DEMOLITION PACKAGE

ALOFT MEMPHIS DOWNTOWN 63 NORTH B.B. KING BLVD. MEMPHIS, TENNESSEE 38103

CRB HOTELS, LLC. 220 GOODMAN RD. EAST SOUTHAVEN, MS 38671

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VIJAY VAGHELA

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EMAIL: vincevaghela@hotmail.com

OWNER / DEVELOPER

JIJI CONSTRUCTION, LLC 208 POWER DRIVE BATESVILLE, MS 38606

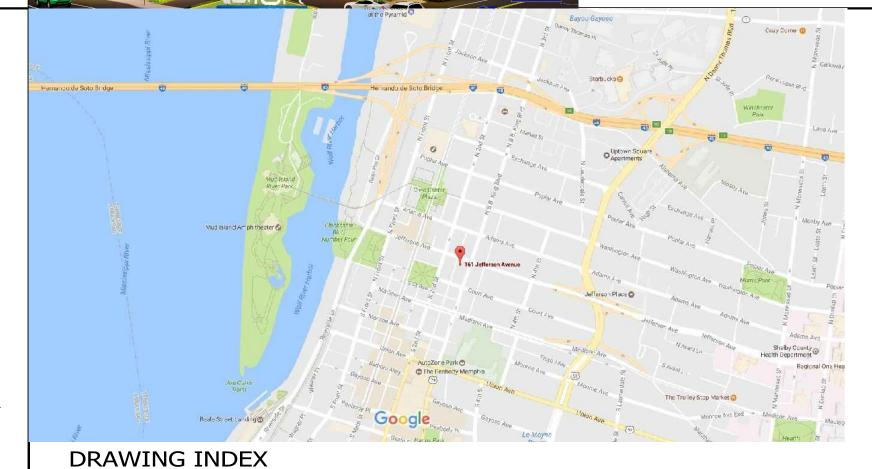
CONTACT:

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CONTRACTOR



VICINITY MAP

JAMES DARRIN WILLIAMS, R.A. 836 GARBOW COURT CHARLOTTE, NC 28270

CONTACT:

JAMES DARRIN WILLIAMS

ARCHITECT OF RECORD

PH: 704-562-1799

EMAIL: JamesDarrinWilliamsArchitect@gmail.com

ARCHITECT OF RECORD

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CONTACT:

APOORVA KULKARNI

PROJECT MANAGER

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HOTEL & RESORT DESIGNER

GRADING AND DRAINAGE PLAN

SECTION AND DETAILS

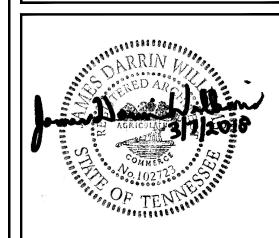
DEMOLITION

DEMOLITION PLAN - SERVICE LEVEL DEMOLITION PLAN - 1st FLOOR D101 DEMOLITION PLAN - 2nd FLOOR D102

D103 DEMOLITION PLAN - GUEST FLOOR AND ROOF D200 **DEMOLITION - EXTERIOR ELEVATIONS**

FOR FINAL APPROVAI

URBAN PLANNING **INTERIORS** HOTELS/ HOUSING/ MIXED USE 1800.630.3750 **CA-SERVICES** ca@mwtusa.com / 1800.717.5816



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63 NORTH B.B. KING BLVD. MEMPHIS, TENNESSEE 38103

PROJECT NO.: 16 006 DATE: 8-4-2017

DRAWN BY: RS, BS, MV,AN CHKD. BY: MWT

COVER SHEET

D-G000 SHEET

PSE DESIGN 1000 HILLCREST RD. SUITE 110 MOBILE, AL 36695

CONTACT:

WILLIAM SEALY

ENGINEER OF RECORD

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EMAIL: WTSEALY@PSEDESIGNS.COM

CIVIL ENGINEER

MEP GREEN DESIGN & BUILD, PLLC 17047 EL CAMINO REAL, SUITE 211 HOUSTON, TX 77058

CONTACT:

DUNG VU

PME ENGINEER

PH: 281-786-1195

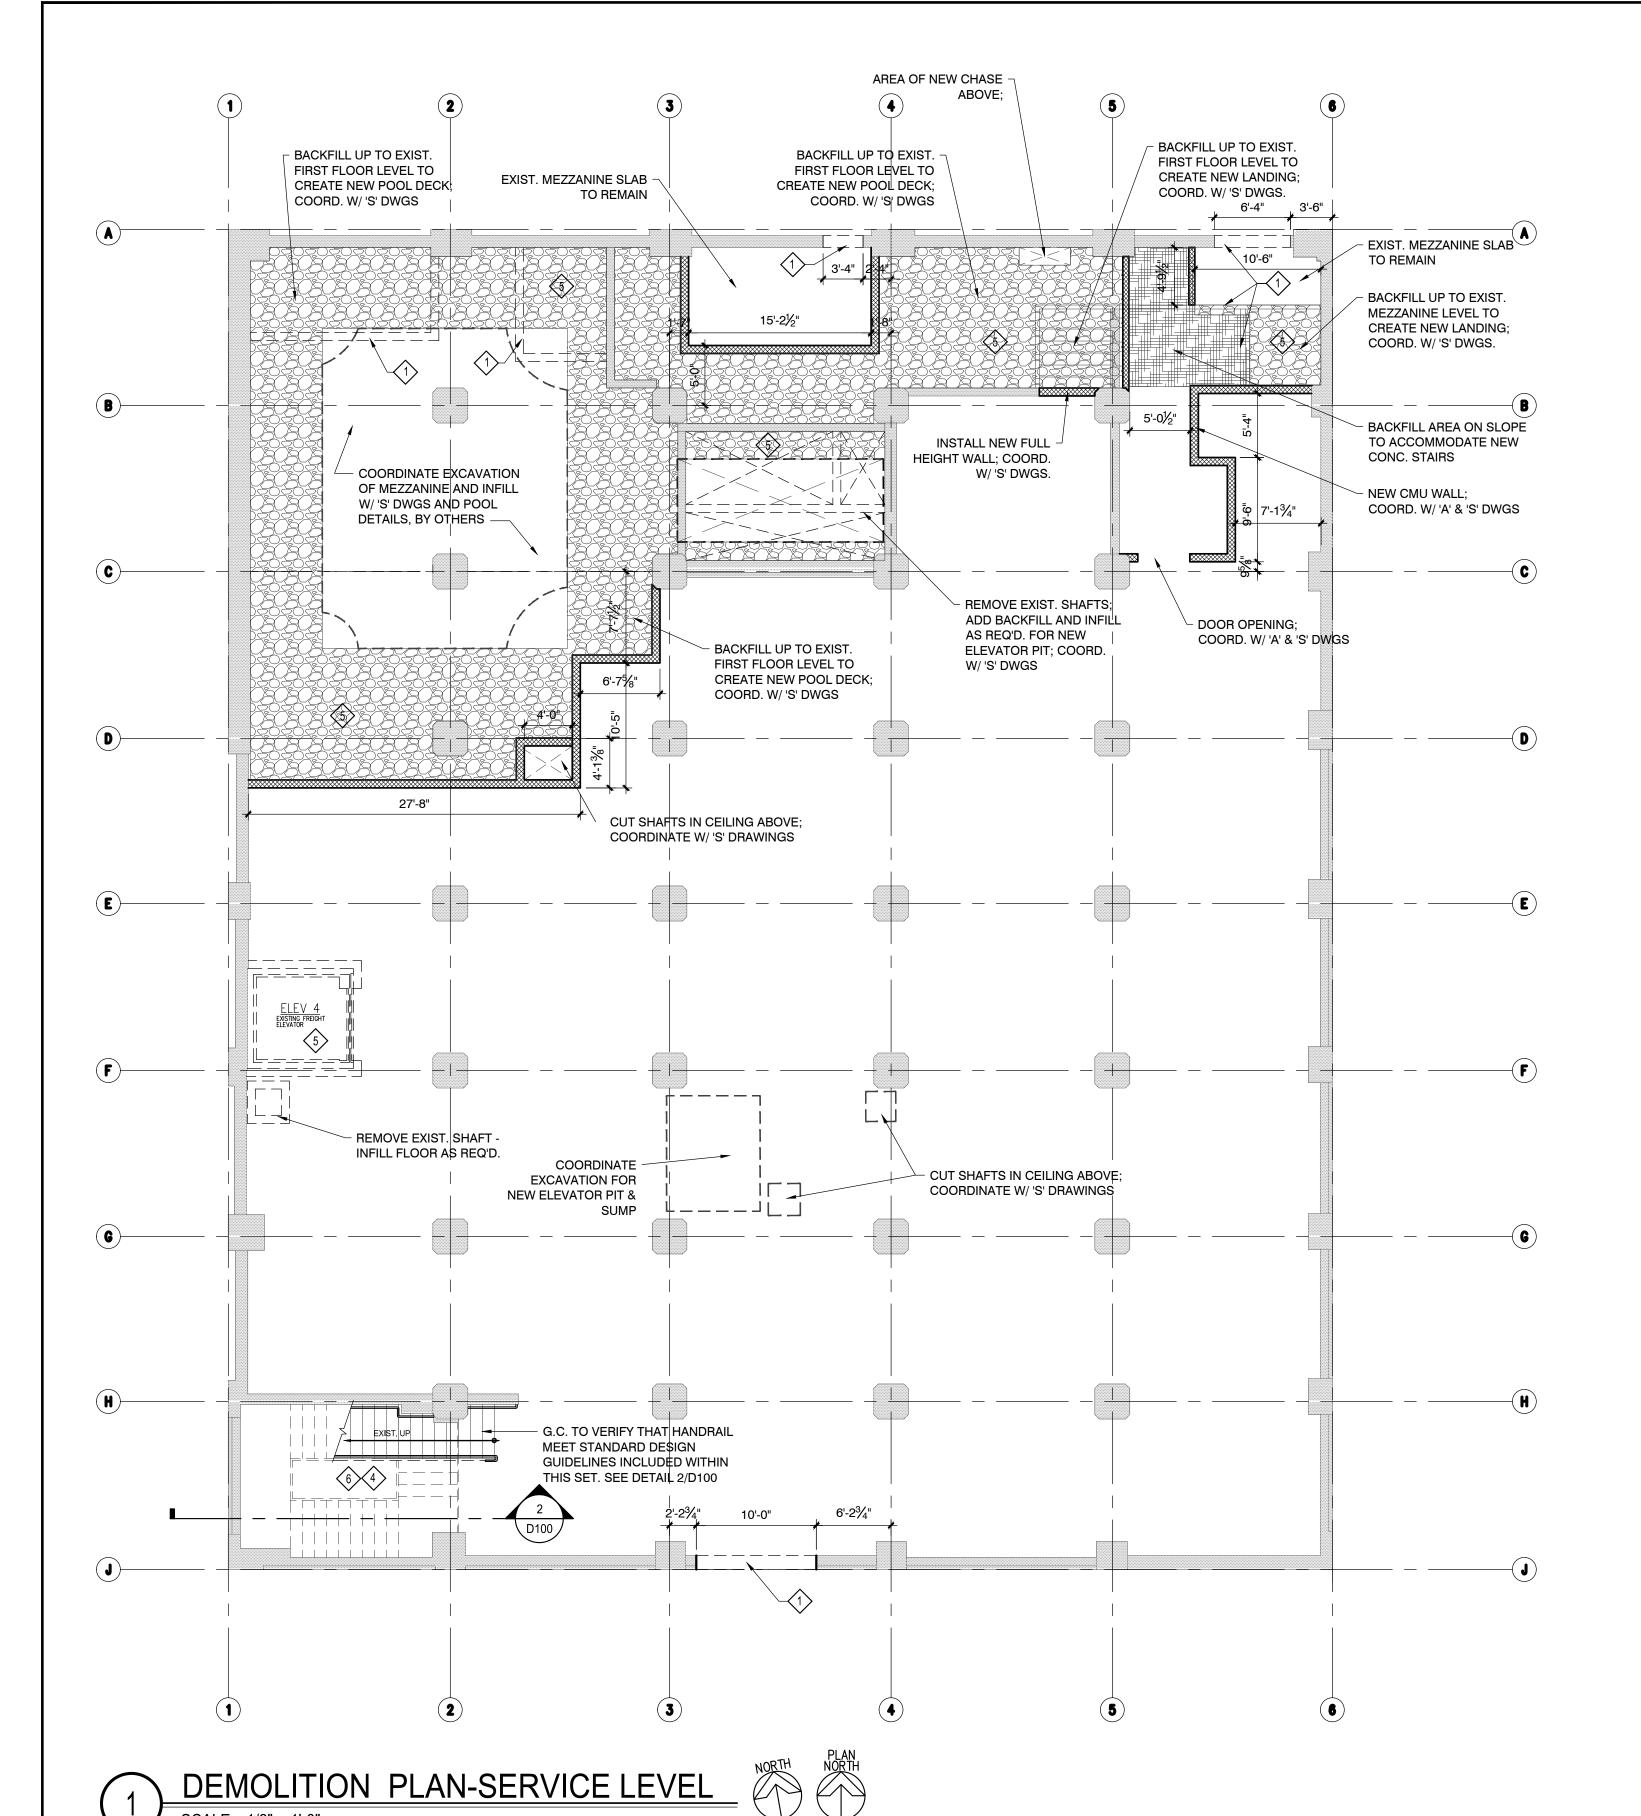
EMAILdungvu@mepgreendesigns.com

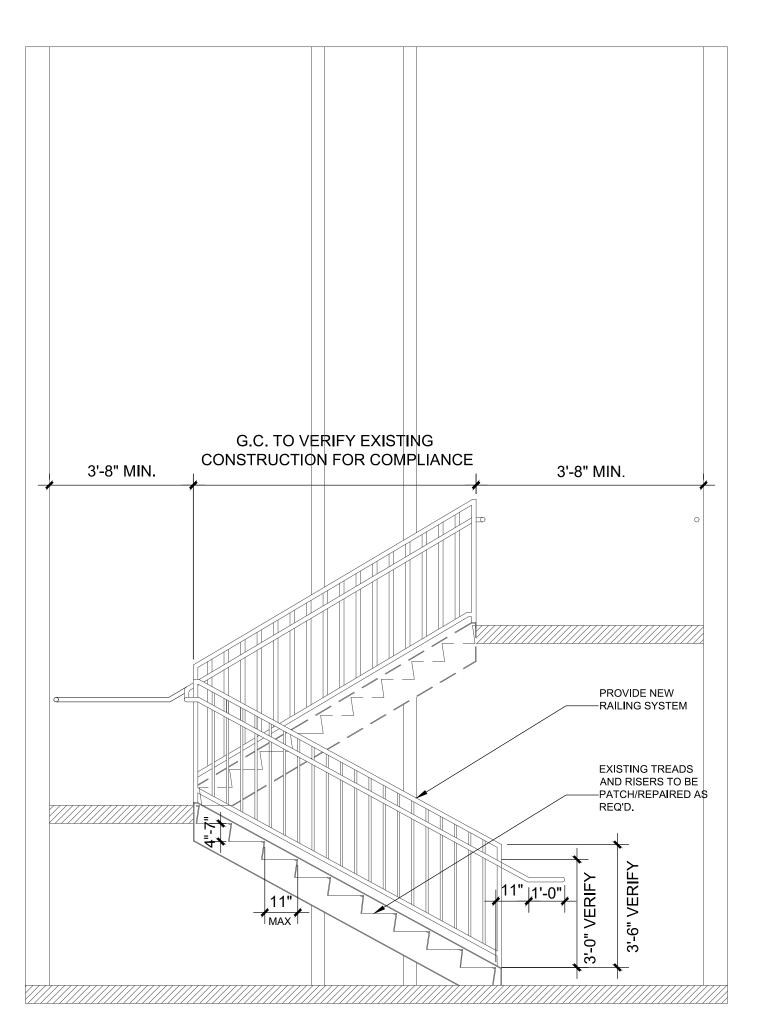
PME ENGINEER OF RECORD

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2 EXISTING STAIR SECTION @ BASEMENT
SCALE: 3/8" = 1'-0"

PLAN KEYED NOTES

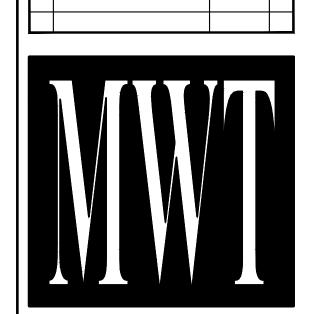
- 1 REMOVE EXIST. WALL
- 2 REMOVE EXIST. DOOR/FRAME
- REMOVE EXIST. WINDOWS
- REMOVE ANY NON-COMPLIANT HANDRAILS
- REMOVE ELEVATOR SHAFT AND ANY ASSOCIATED EQUIPMENT, INCLUDING SUMPS. INFILL FLOOR AS REQ'D.
- EXISTING STAIRS TO REMAIN; G.C. TO VERIFY THAT EXIST. HANDRAIL MEETS OR EXCEED STANDARD HANDRAIL DETAILS PROVIDED IN THIS DRAWING SET.

- ISSUED FOR DEMOLITION 06/09/17 MN - ISSUED TO FRANCHISE 06/09/17 MN - ISSUED FOR BID (ID ONLY) 07/21/17 MN - ISSUED TO FRANCHISE 08/17/17 MN - ISSUED FOR PERMIT 08/04/17 MN - FOR FINAL APPROVAL 10/02/17 MN - ISSUED FOR PERMIT 11/28/17 MN - RE-ISSUED FOR PERMIT 03/07/18 AN - REV. DETAILS ON A700.2 06/04/18 AV I REV. 90% REVIEW COMMENTS 04/24/19 AV

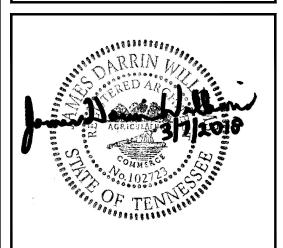
Aloft, Memphis - Notes for Exterior Walls:

DEMOLITION NOTE: Examine the proposed design and structural demolition documents before starting the demolition of the existing exterior perimeter walls. Any demolition of the exterior wall must be done carefully that results in a relatively clean and smooth surface and to maintain the structural integrity of the remaining walls.

- 1. Maintain the existing exterior concrete and masonry perimeter walls, including the concrete spandrels as well as existing window openings as per the structural documents. Where the structural integrity of the existing walls are in question or the walls and/or spandrels are substantially damaged, contact the structural engineer immediately.
- 2. Install the metal steel studs with deflection runner under the slab. Fill the stud cavity with batt insulation. Where the existing wall is thicker below the window, install hat channel furring to anchor the gypsum board and align with the gypsum board above.
- 3. Notify the architect if there is any conflict between the inside finished wall at the exterior perimeter and the new furniture or millwork.
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ALOFT MEMPHIS DOWNTOWN

63 NORTH B.B. KING BLVD. MEMPHIS, TENNESSEE 38103

PROJECT NO.: 16 006 DATE: 8-4-2017

DRAWN BY: RS, BS, MV,AN
CHKD. BY: MWT

DEMOLITION PLAN- SERVICE LEVEL

SHEET D100

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SCALE: 1/8" = 1'-0"

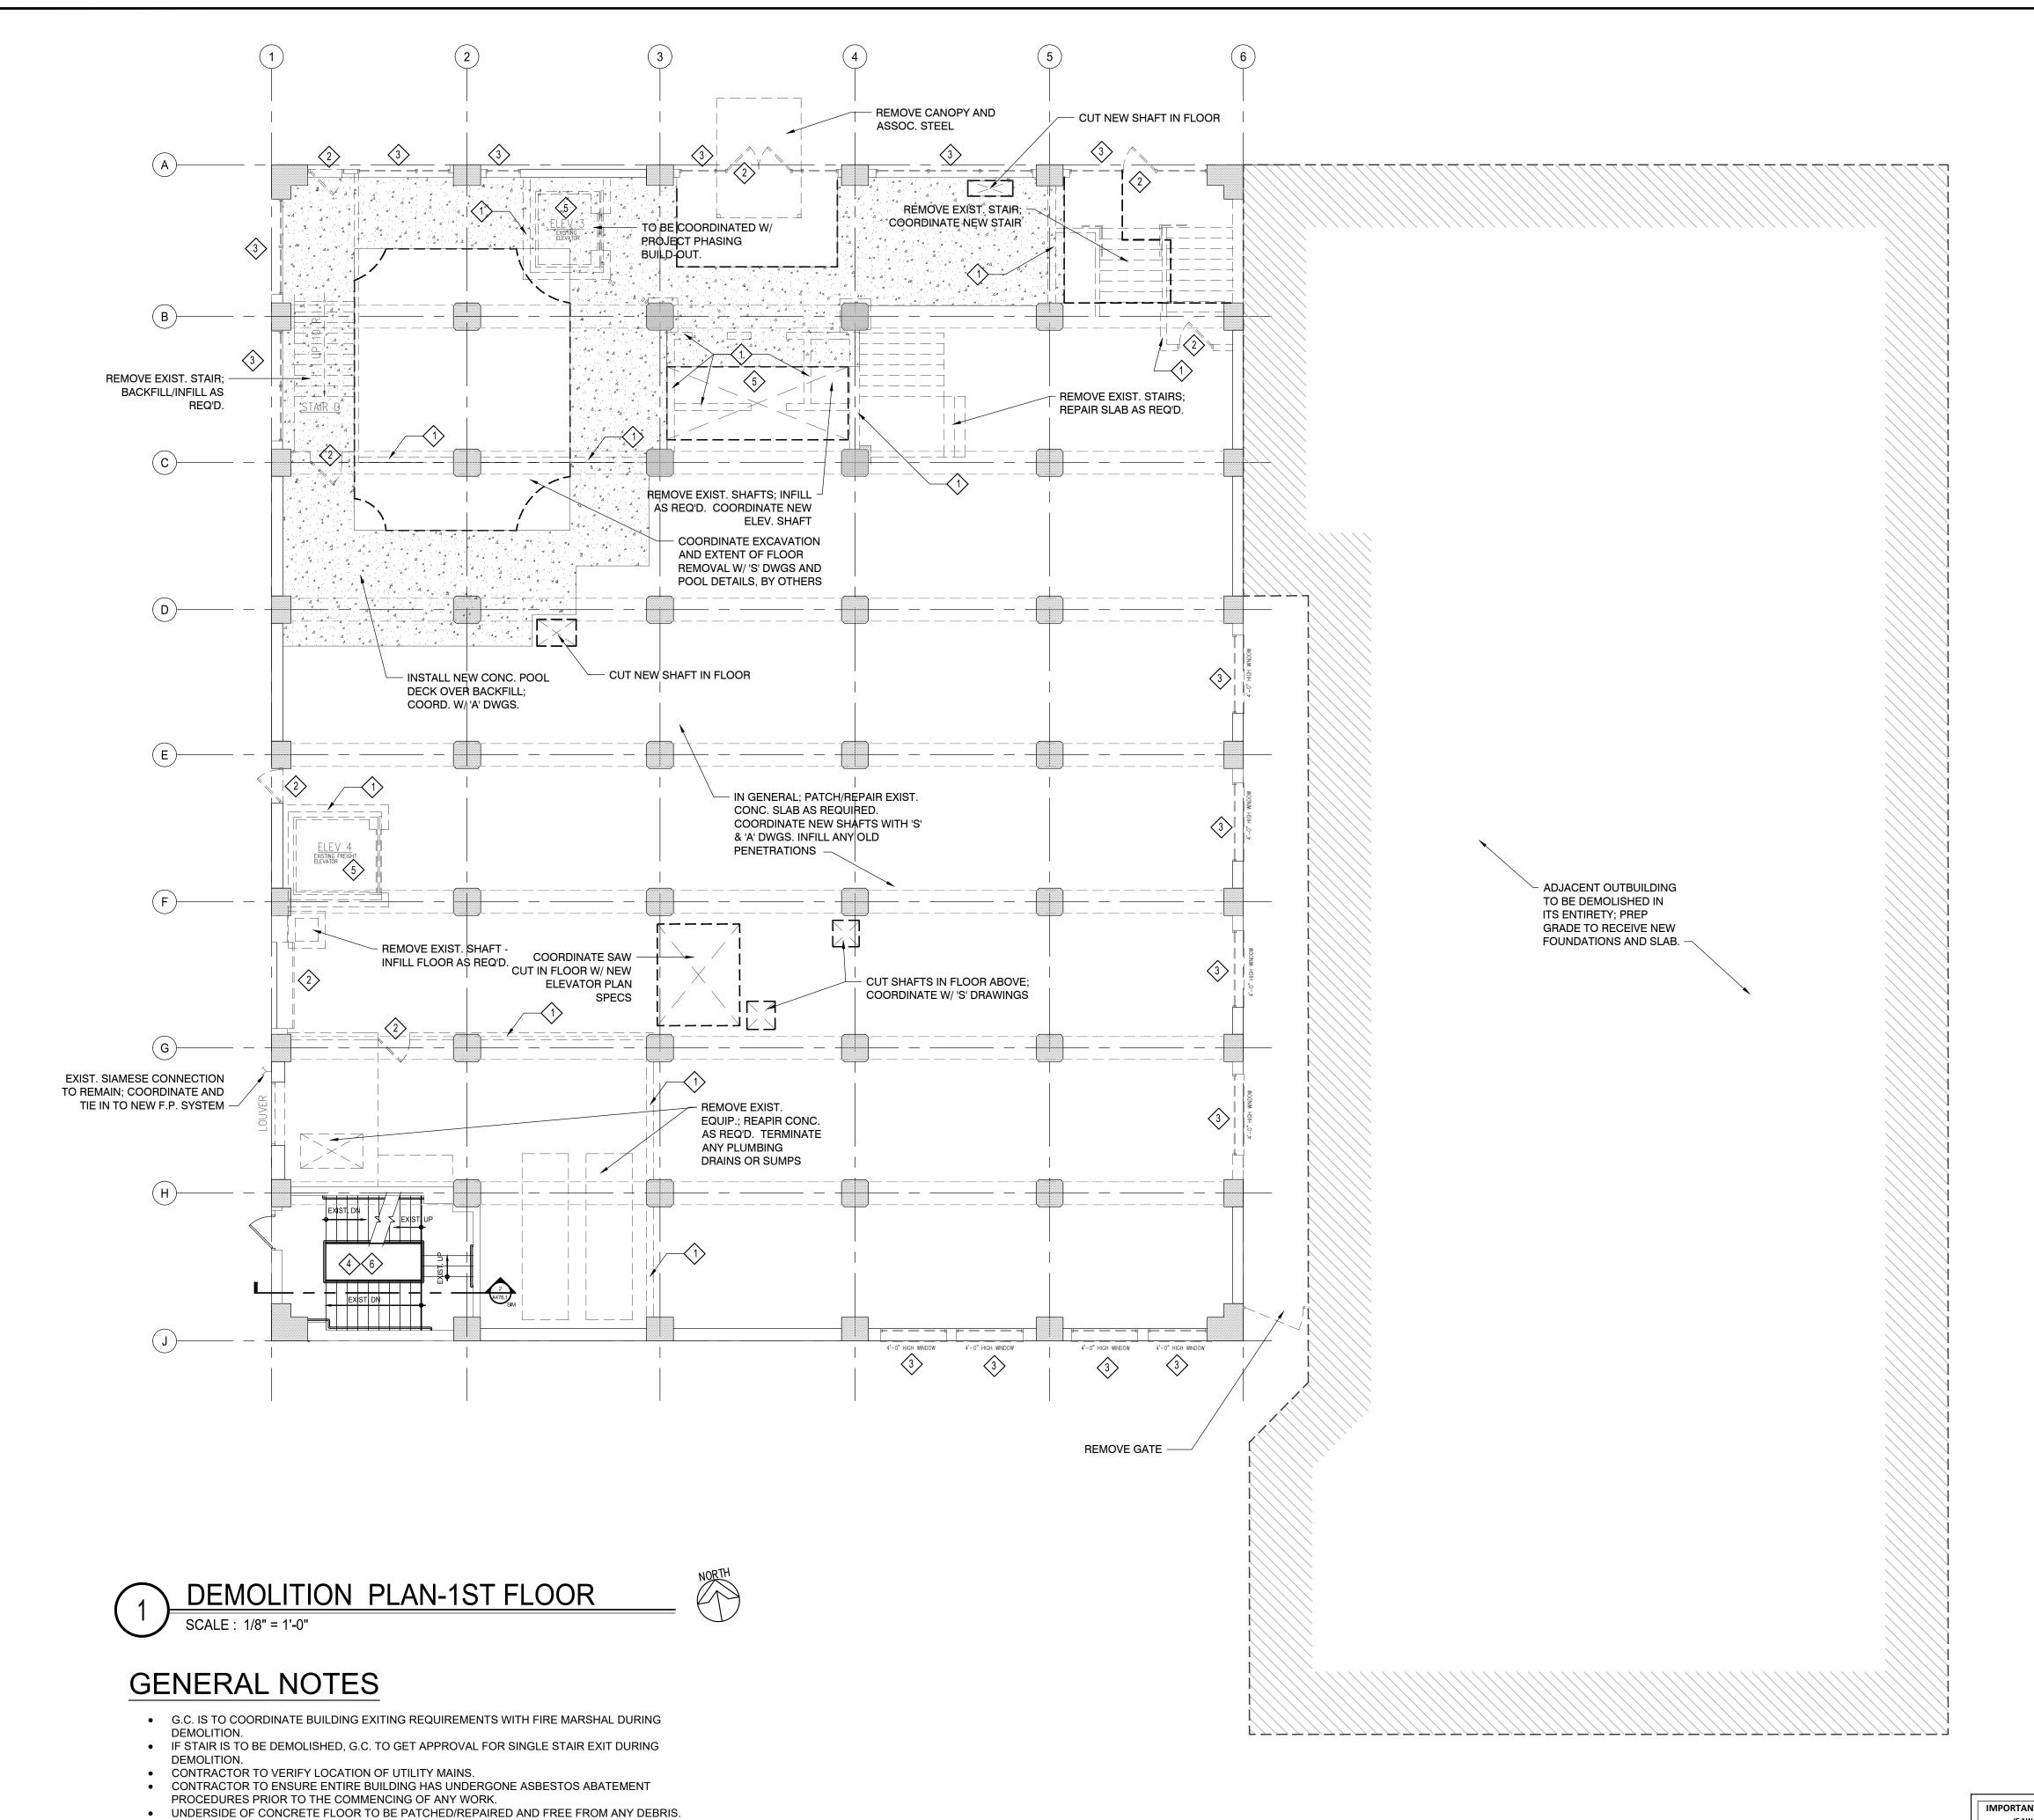
GENERAL NOTES

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- IF STAIR IS TO BE DEMOLISHED, G.C. TO GET APPROVAL FOR SINGLE STAIR EXIT DURING
- DEMOLITION.CONTRACTOR TO VERIFY LOCATION OF UTILITY MAINS.
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 UNDERSIDE OF CONCRETE FLOOR TO BE PATCHED/REPAIRED AND FREE FROM ANY DEBRIS.

 EXISTING FLOOR SHALL BE PREPPED TO RECEIVE NEW FINISH FLOORING, THIS INCLUDES THE
- REMOVAL OF ANY EXIST. FLOOR TILE, AND PATCH/REPAIRING OF CONCRETE. A MIN. $\frac{1}{4}$ " TOPPING SHALL BE APPLIED TO ALL EXIST. FLOOR SLABS AS REQ'D. TO LEVEL OR COVER MAJOR PATCH/REPAIR WORK.
- ALL DOORS, FRAMES AND HARDWARE SHALL BE REMOVED. G.C. TO PROVIDE TEMPORARY
- BUILDING SECURITY.

 ALL WINDOWS AND FRAMES SHALL BE REMOVED



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PLAN KEYED NOTES

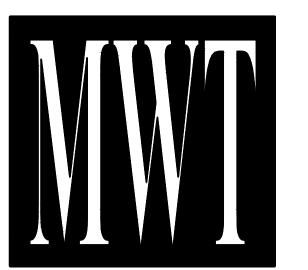
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Aloft, Memphis - Notes for Exterior Walls:

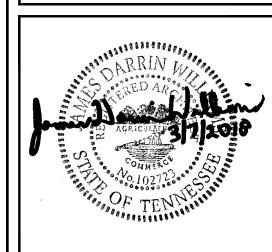
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NO.	DESCRIPTION	DATE	BY
1	ISSUED FOR DEMOLITION	06/09/17	ΜV
-	ISSUED TO FRANCHISE	06/09/17	ΜV
-	ISSUED FOR BID (ID ONLY)	07/21/17	ΜV
-	ISSUED TO FRANCHISE	08/17/17	ΜV
-	ISSUED FOR PERMIT	08/04/17	M١
-	FOR FINAL APPROVAL	10/02/17	ΜV
-	ISSUED FOR PERMIT	11/28/17	ΜV
-	RE-ISSUED FOR PERMIT	03/07/18	AN
-	REV. DETAILS ON A700.2	06/04/18	AVK
	REV. 90% REVIEW		
	COMMENTS	04/24/19	ΑV



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ALOFT MEMPHIS DOWNTOWN

63 NORTH B.B. KING BLVD. MEMPHIS, TENNESSEE 38103

PROJECT NO.: 16 006
DATE: 8-4-2017

DRAWN BY: RS, BS, MV,AN
CHKD. BY: MWT

DEMOLITION
PLAN- 1st FLOOR

SHEET D101

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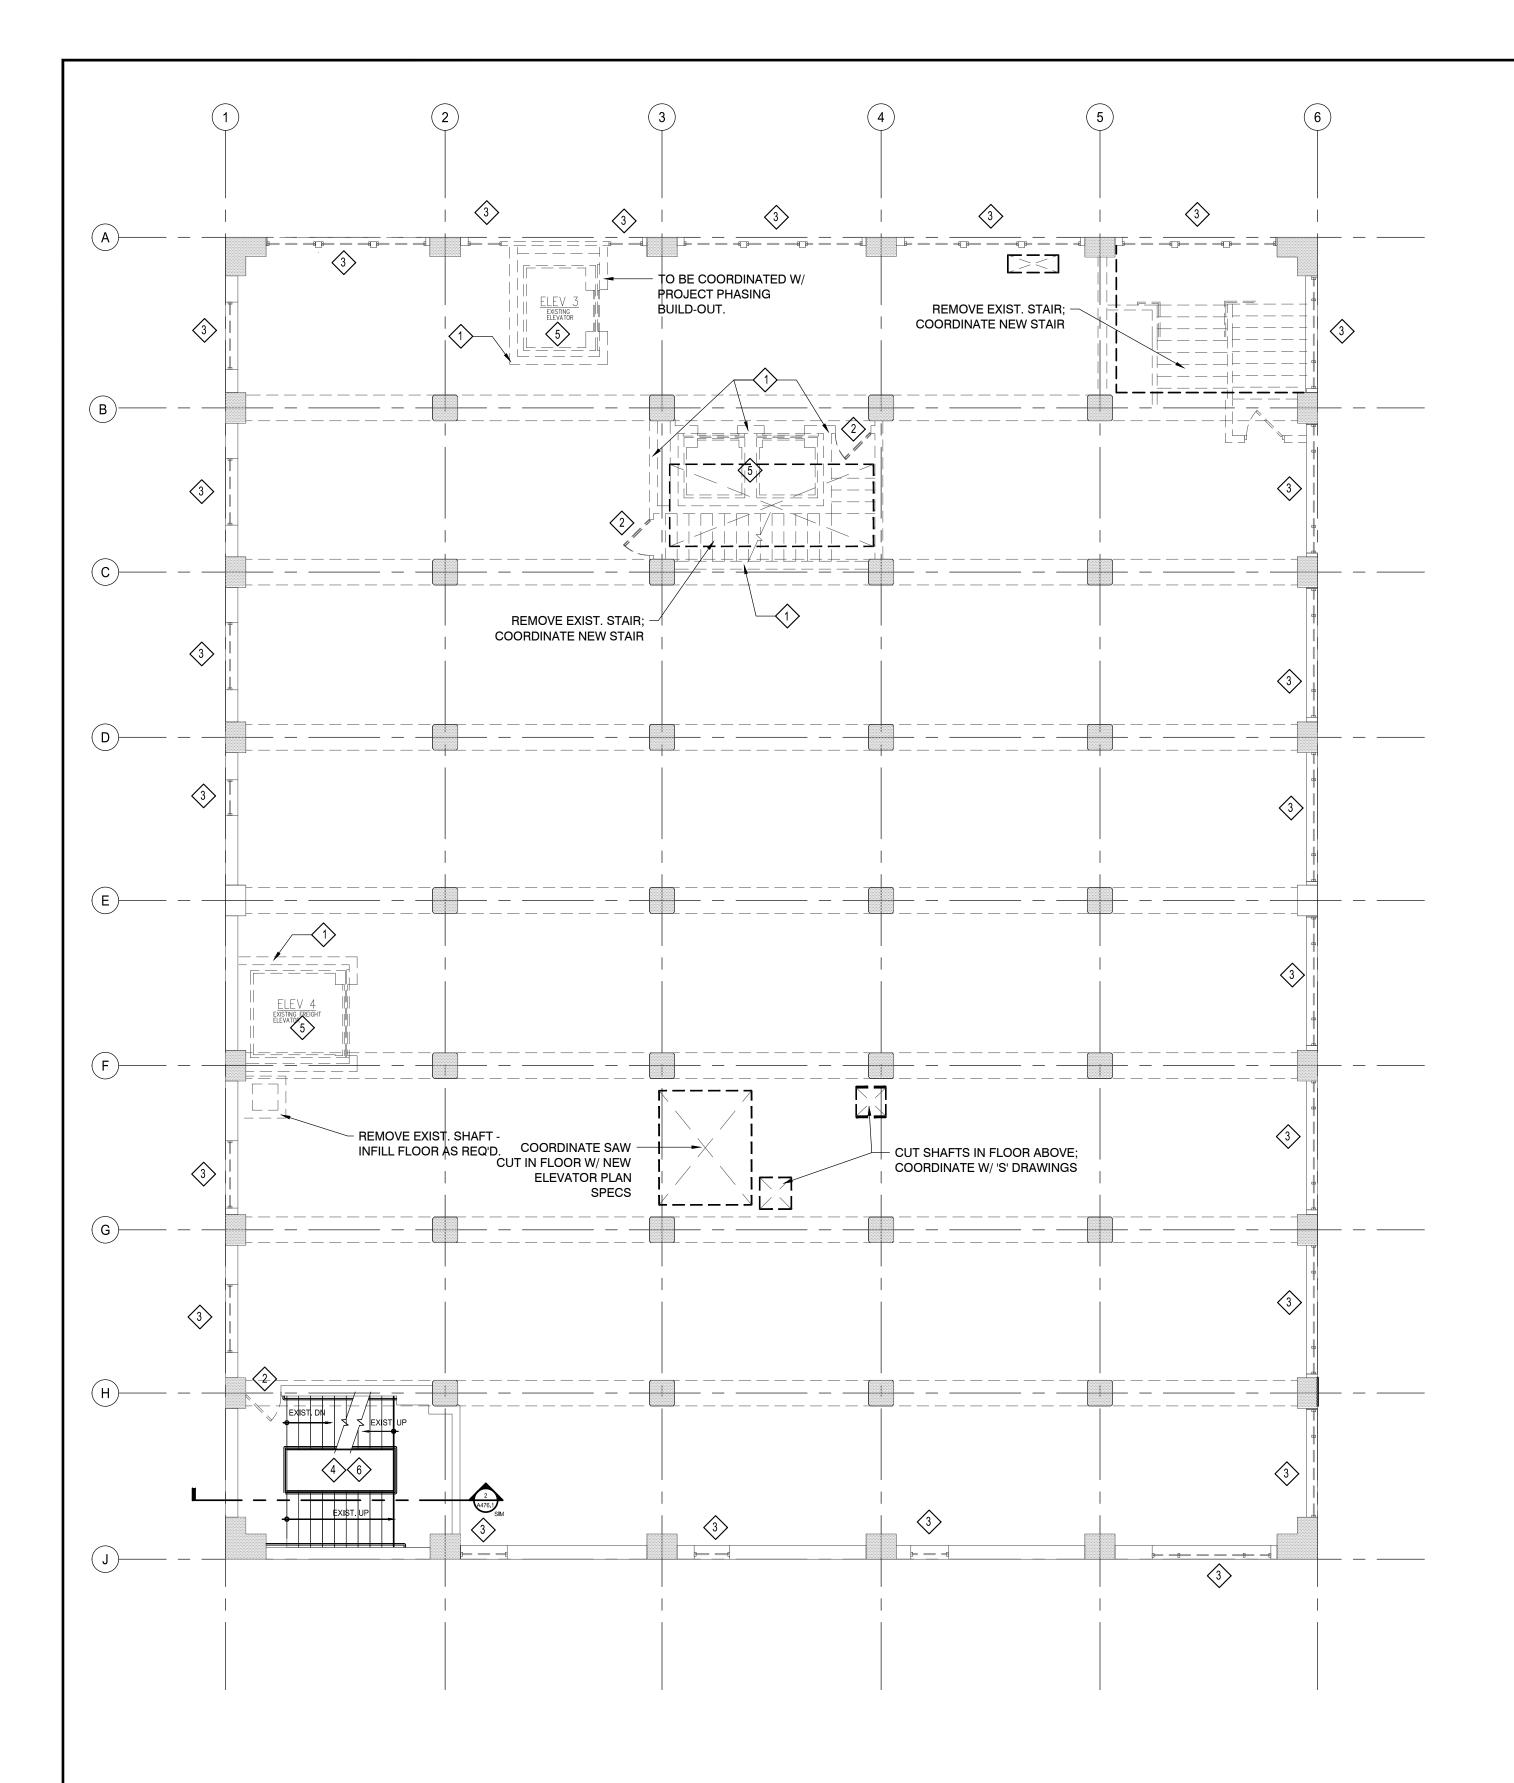
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DEMOLITION PLAN-2nd THRU 4th FLOOR SCALE: 1/8" = 1'-0"

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PLAN KEYED NOTES

REMOVE EXIST. WALL

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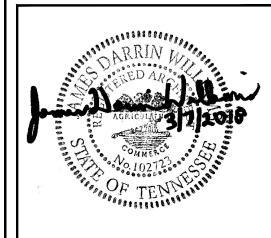
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	REV. 90% REVIEW		
	COMMENTS	04/24/19	AVK



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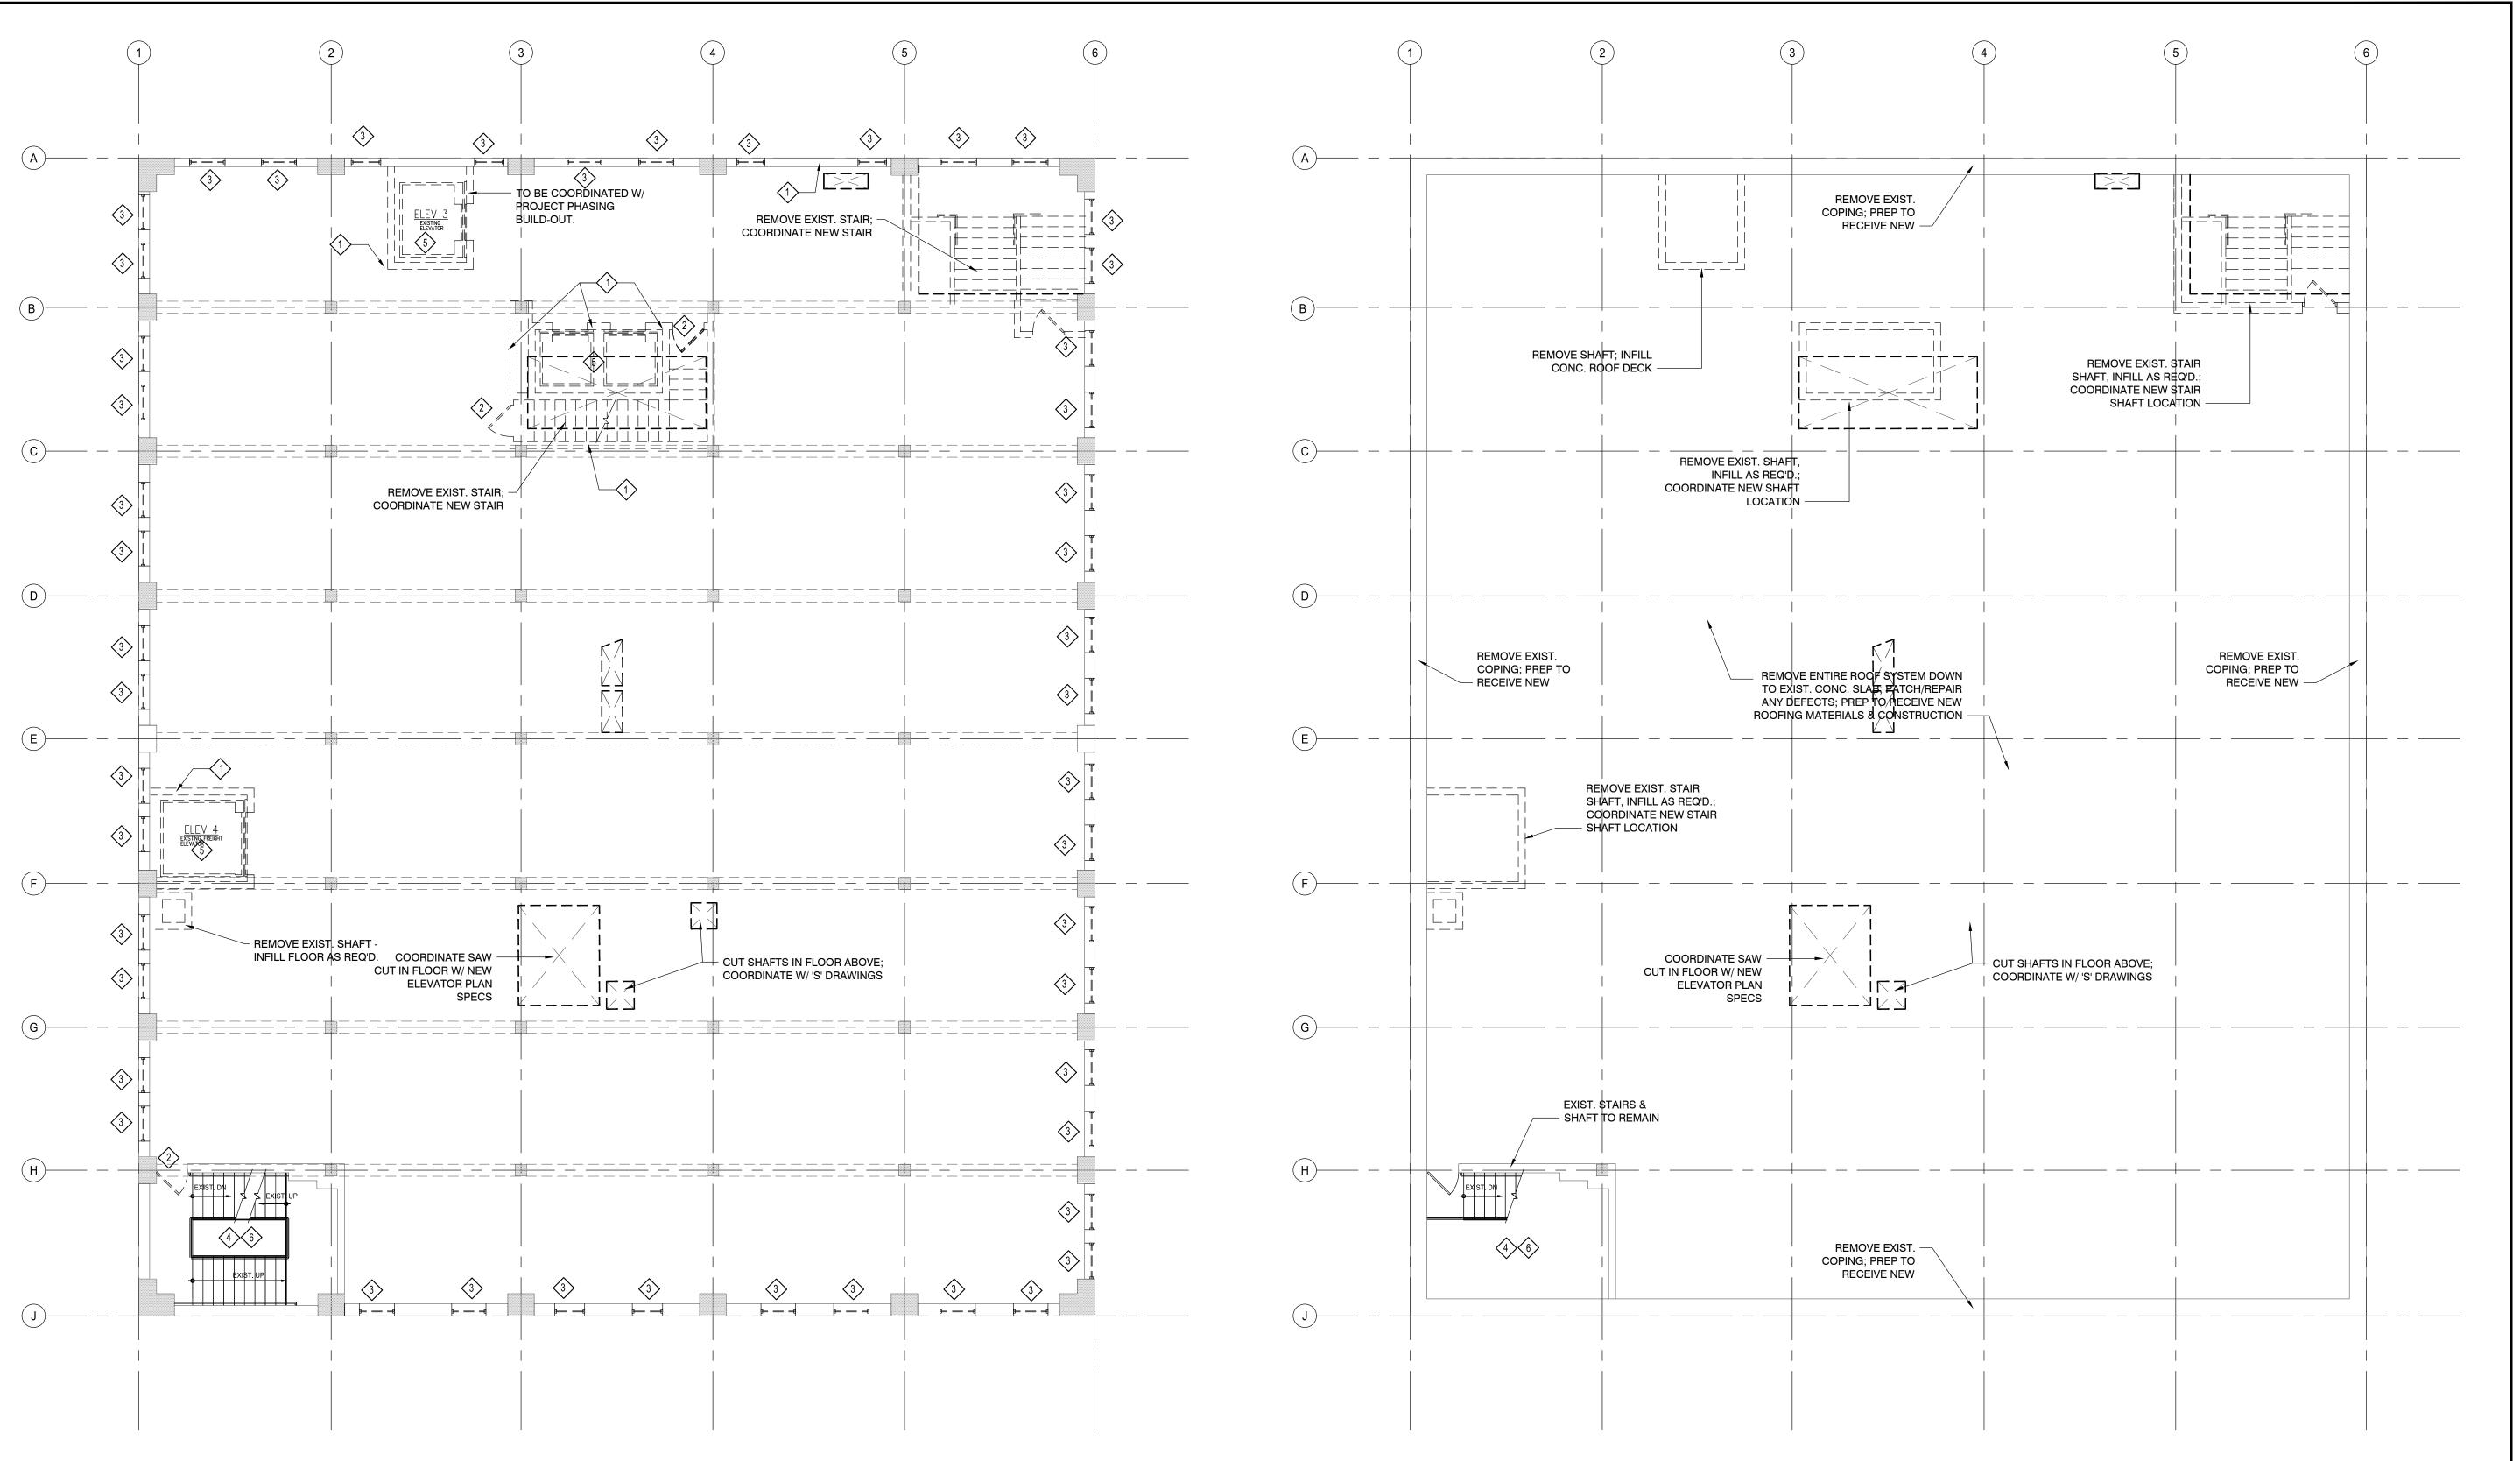
DEMOLITION PLAN- 2nd THRU 4th FLOOR

D102

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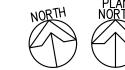
DEMOLITION NOTE: Examine the proposed design and structural demolition documents before starting the demolition of the DEMOLITION PLAN-5th FLOOR AND UP

SCALE: 1/8" = 1'-0" existing exterior perimeter walls. Any demolition of the exterior wall must be done carefully that results in a relatively clean and smooth surface and to maintain the structural integrity of the remaining walls.

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DEMOLITION PLAN - ROOF

SCALE: 1/8" = 1'-0"





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ARCHITECTURE

URBAN PLANNING **INTERIORS** HOTELS/ HOUSING/ MIXED USE 1800.630.3750 CA-SERVICES ca@mwtusa.com / 1800.717.5816

DESCRIPTION ISSUED FOR DEMOLITION ISSUED TO FRANCHISE ISSUED FOR BID (ID ONLY) ISSUED TO FRANCHISE ISSUED FOR PERMIT FOR FINAL APPROVAL ISSUED FOR PERMIT RE-ISSUED FOR PERMIT

REV. DETAILS ON A700.2

REV. 90% REVIEW

63 NORTH B.B. KING BLVD. MEMPHIS, TENNESSEE 38103

PROJECT NO.: 16 006

DATE: 8-4-2017

DRAWN BY: RS, BS, MV,AN CHKD. BY: MWT

DEMOLITION PLAN-GUEST FLR & ROOF

D103

GENERAL NOTES

- G.C. IS TO COORDINATE BUILDING EXITING REQUIREMENTS WITH FIRE MARSHAL DURING
- IF STAIR IS TO BE DEMOLISHED, G.C. TO GET APPROVAL FOR SINGLE STAIR EXIT DURING
- DEMOLITION. CONTRACTOR TO VERIFY LOCATION OF UTILITY MAINS.
- CONTRACTOR TO ENSURE ENTIRE BUILDING HAS UNDERGONE ASBESTOS ABATEMENT PROCEDURES PRIOR TO THE COMMENCING OF ANY WORK.
- UNDERSIDE OF CONCRETE FLOOR TO BE PATCHED/REPAIRED AND FREE FROM ANY DEBRIS. EXISTING FLOOR SHALL BE PREPPED TO RECEIVE NEW FINISH FLOORING, THIS INCLUDES THE REMOVAL OF ANY EXIST. FLOOR TILE, AND PATCH/REPAIRING OF CONCRETE. A MIN. 1/4" TOPPING SHALL BE APPLIED TO ALL EXIST. FLOOR SLABS AS REQ'D. TO LEVEL OR COVER MAJOR PATCH/REPAIR WORK.
- ALL DOORS, FRAMES AND HARDWARE SHALL BE REMOVED. G.C. TO PROVIDE TEMPORARY BUILDING SECURITY.
- ALL WINDOWS AND FRAMES SHALL BE REMOVED

PLAN KEYED NOTES

1 REMOVE EXIST. WALL

2 REMOVE EXIST. DOOR/FRAME

REMOVE ANY NON-COMPLIANT HANDRAILS

REMOVE EXIST. WINDOWS

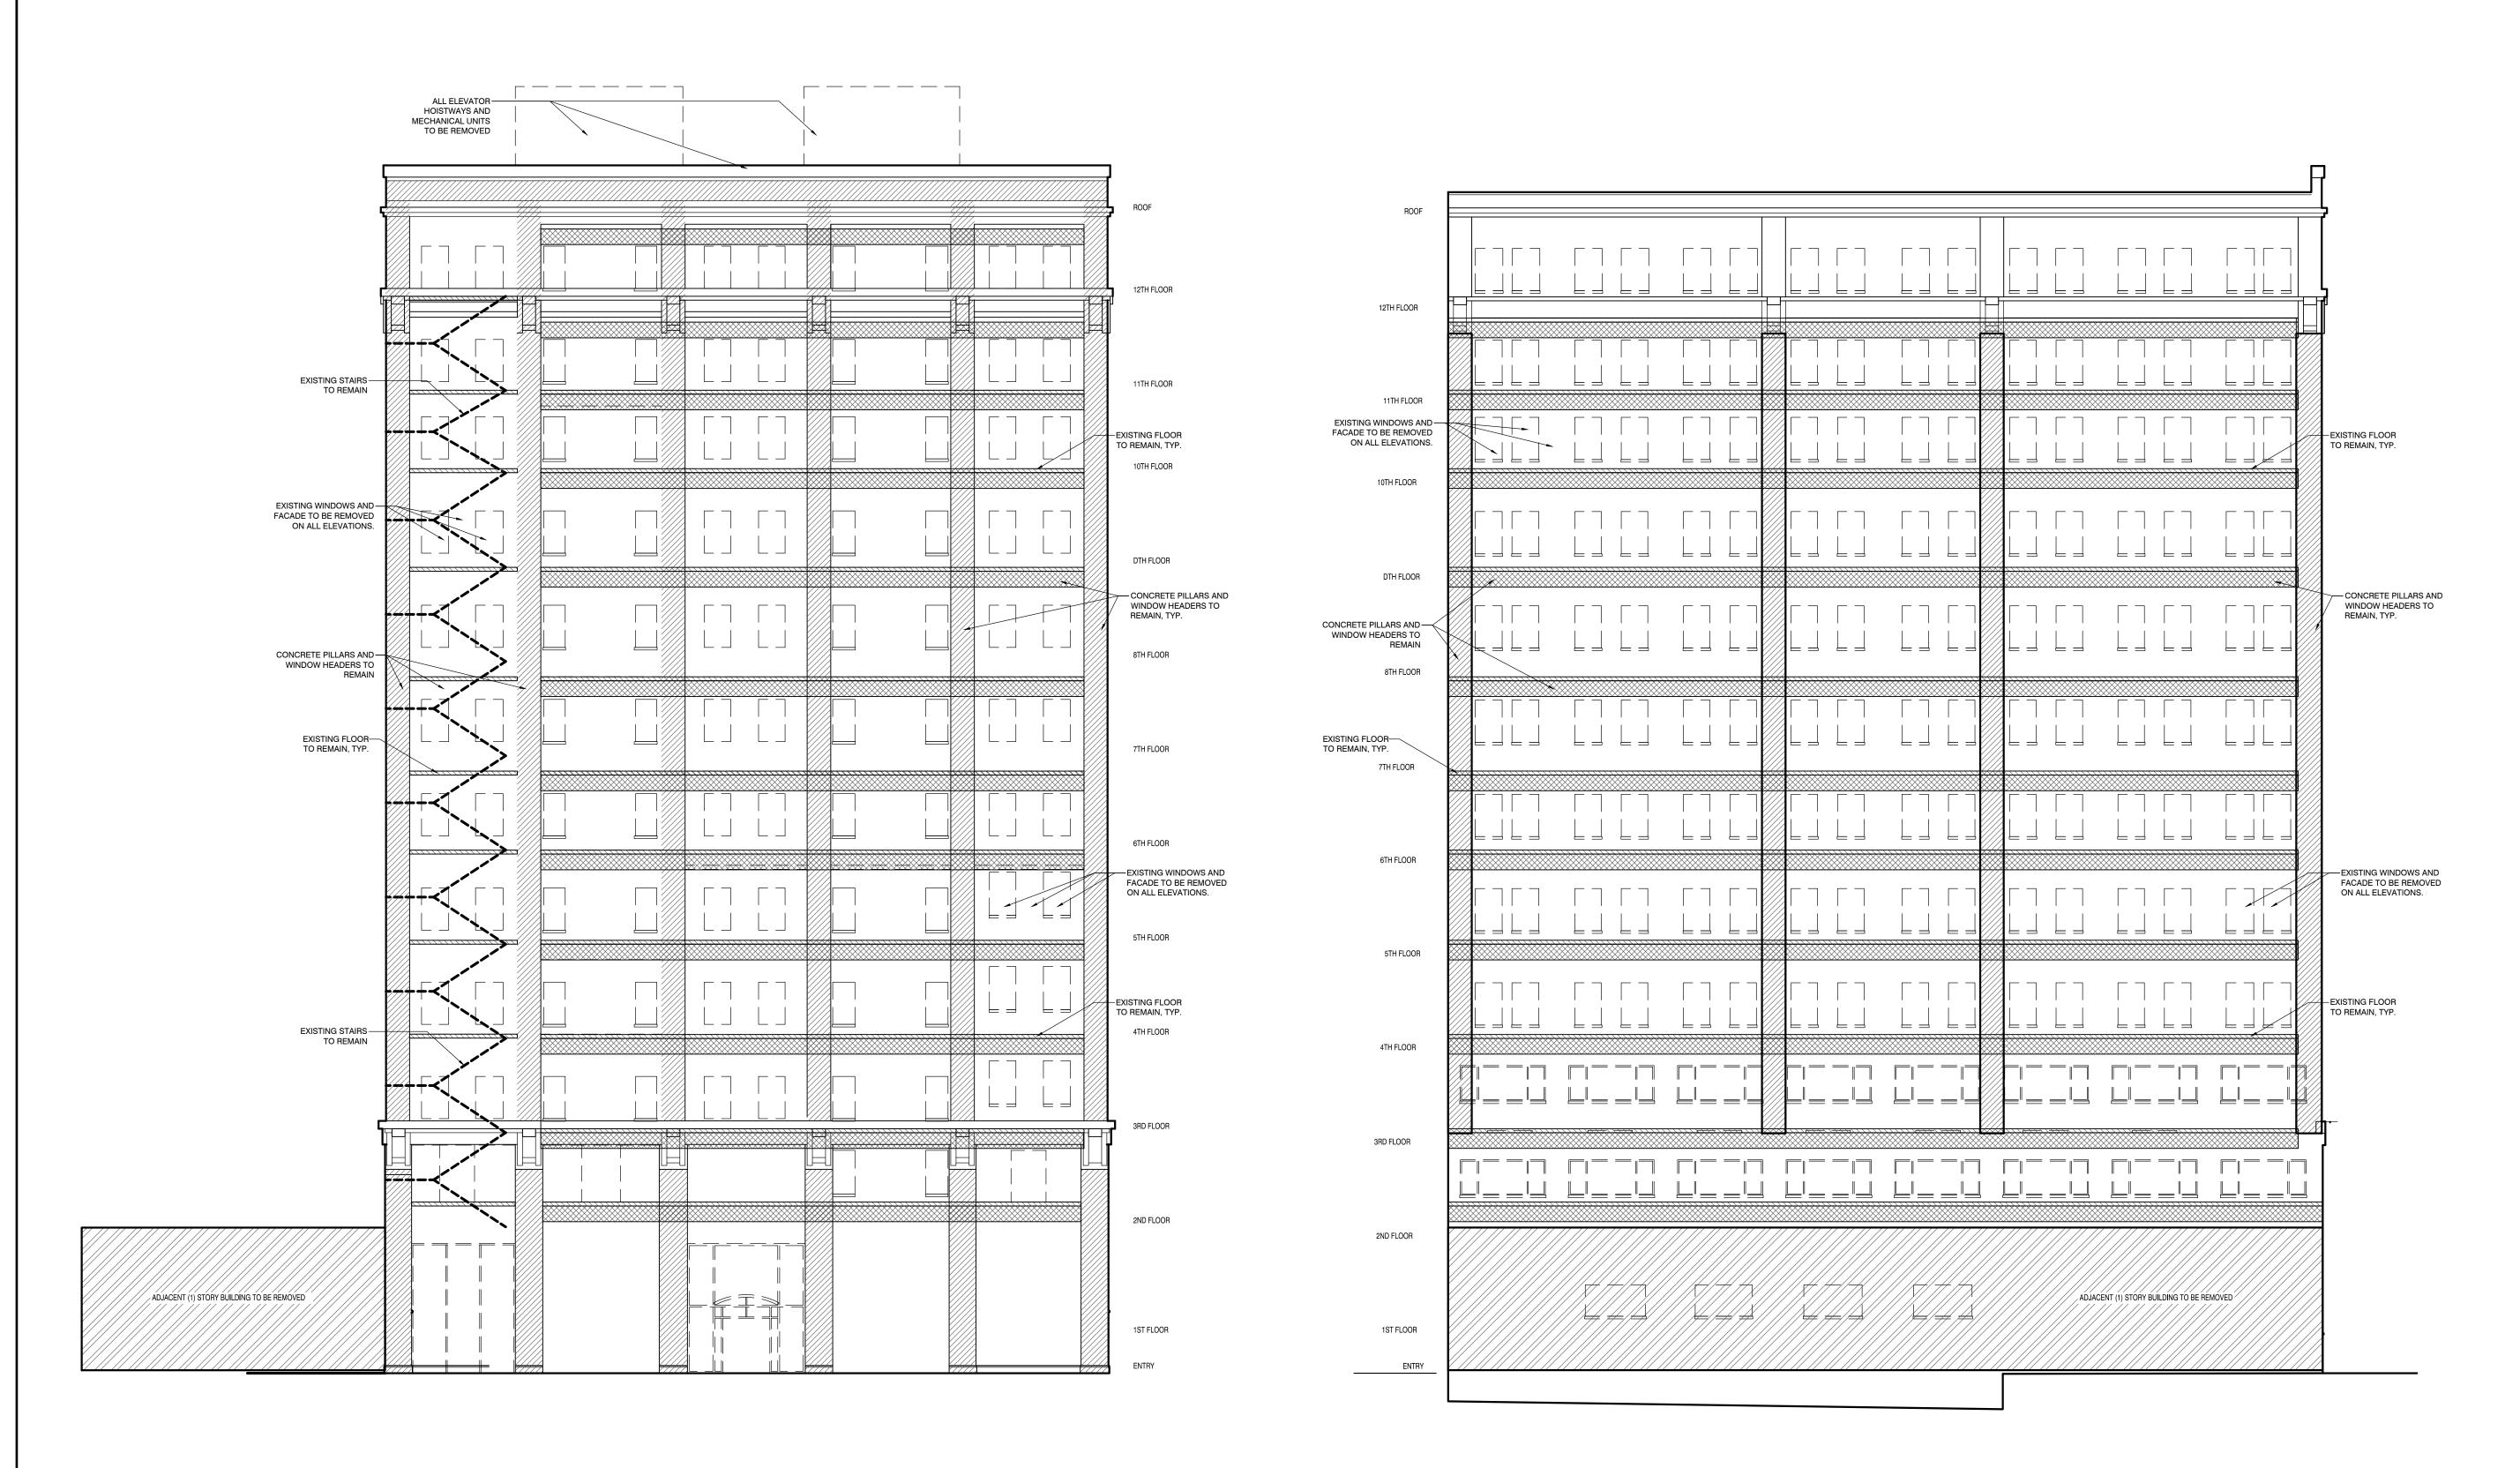
REMOVE ELEVATOR SHAFT AND ANY ASSOCIATED EQUIPMENT, INCLUDING SUMPS. INFILL FLOOR AS REQ'D.

EXISTING STAIRS TO REMAIN; G.C. TO VERIFY THAT EXIST. HANDRAIL MEETS OR EXCEED STANDARD HANDRAIL DETAILS PROVIDED IN THIS DRAWING SET.

IMPORTANT NOTICE TO ALL CONTRACTORS AND OR SUBCONTRACTORS: (COMPLETE BUILDING SYSTEMS AND OR INSTALLATIONS) IF AWARDED A CONTRACT FOR ANY PORTION OF WORK NEEDED TO COMPLETE THIS PROJECT YOU ARE AGREEING TO THE FOLLOWING TERMS: YOU ARE A QUALIFIED CONTRACTOR AND OR SUBCONTRACTOR SPECIFICALLY IN PROVIDING A COMPLETE TURNKEY SERVICE IN YOUR TRADE OR PROFESSION FOR THE TYPE OF WORK AND SCOPE FOR THIS PROJECT.

YOU AGREE TO PROVIDE A COMPLETE DESIGN BUILD SOLUTION BASED ON THE ARCHITECTS INTENDED DESIGN FOR THIS PROJECT. YOUR BID INCLUDED ALL THE STEPS, PROCESSES, MATERIALS, PRODUCTS, GOVERNING PERMITS AND APPROVALS NECESSARY TO PROVIDE A COMPLETED AND WARRANTED SYSTEM OR INSTALLATION THAT DOES NOT REQUIRED ANOTHER CONTRACTOR OR PRODUCT TO COMPLETE YOUR SCOPE OF WORK. YOUR BID MUST HAVE INCLUDED ANY DESIGN INFORMATION REFERENCED WITHIN ANY CIVIL, ARCHITECTURAL, STRUCTURAL, MECHANICAL, ELECTRICAL AND OR PLUMBING DRAWINGS; ALSO NOTE THESE DRAWINGS ARE SCHEMATIC AND ARE INTENDED TO SHOW ONLY BASIC CONCEPTS AND GENERAL INFORMATION THE COMPLETION OF YOUR WORK MAY INCLUDE OTHER STEPS, PROCESSES, MATERIALS, PRODUCTS, LABOR, GOVERNING PERMITS AND OR APPROVALS NECESSARY TO PROVIDE A COMPLETE SYSTEM INSTALLATION WHETHER SUGGESTED ON THE DRAWINGS OR NOT.

AS AN EXAMPLE: ITEMS AND OR TASKS LIKE; FIRE CAULK, DRAFT STOPS, FASTENERS, ANCHORS, EMBEDMENTS, DUMPSTERS, DEBRIS CLEAN UP, ETC. ARE YOUR RESPONSIBILITY. ANY WORK NOT COMPLETED IN A TIMELY MANNER, OR INCOMPLETE WORK WILL BE BILLED BACK TO THE CONTRACTOR AND OR SUBCONTRACTOR, AT THE OWNERS' DISCRETION.





Aloft, Memphis - Notes for Exterior Walls:



DEMOLITION NOTE: Examine the proposed design and structural demolition documents before starting the demolition of the existing exterior perimeter walls. Any demolition of the exterior wall must be done carefully that results in a relatively clean and smooth surface and to maintain the structural integrity of the remaining walls.

- 1. Maintain the existing exterior concrete and masonry perimeter walls, including the concrete spandrels as well as existing window openings as per the structural documents. Where the structural integrity of the existing walls are in question or the walls and/or spandrels are substantially damaged, contact the structural engineer immediately.
- 2. Install the metal steel studs with deflection runner under the slab. Fill the stud cavity with batt insulation. Where the existing wall is thicker below the window, install hat channel furring to anchor the gypsum board and align with the gypsum board above.
- 3. Notify the architect if there is any conflict between the inside finished wall at the exterior perimeter and the new furniture or millwork.
- 4. See architectural specifications for patch and repair the existing concrete masonry.
- 5. Install vertical metal furring, exterior sheathing, weather barrier and EFIS system on the exterior surface of the existing perimeter of the building. Anchor the furring to the concrete or masonry wall to withstand the wind uplift load prescribed by the engineer.
- 6. Remove the portion of the spandrel to install the Ptac units per structural engineers instructions.
- 7. Fill out the open pockets of the masonry walls with metal studs, filled with batt insulation.
- 8. Windows: Patch & Repair the existing window openings to receive the new window system. Install galvanized metal angle at the exterior corner of the existing wall to anchor the window framing.

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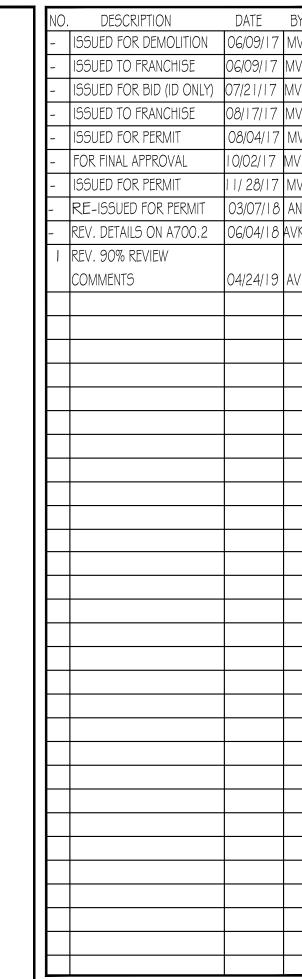
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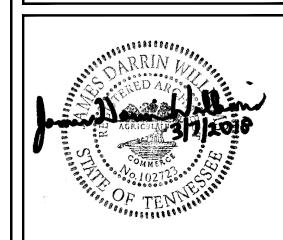
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DEMOLITION ELEVATIONS

SHEET D200