TAG	FIXTURE TYPE	LUMBING FIXTU	TRIM AND REMARKS	TRAP		IN. SIZ		
				SIZE	SW	SV	CW	HW
WC-1	WATER CLOSET, REGULAR, WHITE VITREOUS CHINA, ELONGATED BOWL, FLOOR MOUNTED, REAR OUTLET, KOHLER K-3652.	FLUSH TANK	SEAT TO BE ELONGATED, OPEN FRONT, SOLID PLASTIC WITH SELF SUSTAINING CHECK HINGES, COLOR WHITE. RIM HEIGHT TO BE 15"AFF.	INT.	3"	2"	1/2"	
WC-2	WATER CLOSET, ADA, WHITE VITREOUS CHINA, ELONGATED BOWL, FLOOR MOUNTED, REAR OUTLET, KOHLER K-3578. CONTRACTOR TO VERIFY LEFT OR RIGHT.	FLUSH TANK	SEAT TO BE ELONGATED, OPEN FRONT, SOLID PLASTIC WITH SELF SUSTAINING CHECK HINGES, COLOR WHITE. RIM HEIGHT TO BE 17"AFF.	INT.	3"	2"	1/2"	
WC-3	WATER CLOSET, ADA, WHITE VITREOUS CHINA, ELONGATED BOWL, FLOOR MOUNTED, 1-1/2" TOP SPUD, SIPHON JET ACTION, AMERICAN STANDARD 3043-001 OR EQUAL.	1.6 GPF, INTEGRAL VACUUM BREAKER, SCREWDRIVER/CHECK STOP, ZURN Z6000AV OR EQUAL.PROVIDE TRAP PRIMER OPTION WHERE REQUIRED.	SEAT TO BE ELONGATED, OPEN FRONT, SOLID PLASTIC WITH SELF SUSTAINING CHECK HINGES, COLOR WHITE, BEMIS 1955SSC.	INT.	4*	2"	1 **	
L-1	LAVATORY, WHITE VITREOUS CHINA, UNDERMOUNT, 13-1/4" ROUND, KOHLER K-2298.	POLISHED CHROME-PLATED CAST BRASS, 0.5 GPM AERATOR, SINGLE LEVER HANDLE, SINGLE HOLE, CHICAGO 2200-ABCP.	1-1/4" GRID WITH TAILPIECE, ZURN Z8743-PC. P-TRAP TO BE 1-1/2" BRASS (17 GA. MIN), ZURN ZR361-RB. PROVIDE STOPS, ZURN Z8800 SERIES.		1-1/2"	1-1/2"	1/2"	1/2
L-2	LAVATORY, COUNTERTOP, WHITE VITREOUS CHINA, DROP IN, 19" OVAL, KOHLER K-2906-1.	STAINLESS STEEL, WIDESPREAD INSTALLATION, WRIST BLADE HANDLES, 1.5 GPM, DELTA 3538LF-SS.	1-1/4" GRID WITH TAILPIECE, ZURN Z8743-PC. P-TRAP TO BE 1-1/2" BRASS (17 GA. MIN), ZURN ZR361-RB. PROVIDE STOPS, ZURN Z8800 SERIES.		1-1/2"	1-1/2"	1/2"	1/2'
SH-1	TILE SHOWER, REGULAR	SHOWER VALVE, SHOWER TRIM, SPRAY HEAD, 36"SLIDE BAR, DIVERTER VALVE, 2"DIAMETER ROD, AMERICAN STANDARD 1662.213 OR EQUAL. SHOWERHEAD, MOEN 3838 OR EQUAL.	PROVIDE KOHLER K-7213-CP DRAIN. REFER TO ARCH SERIES FOR MOUNTING HEIGHTS. PROVIDE BLOCKING FOR SUPPORT & INSTALL PER MANUFACTURER RECOMMENDATIONS.	2"	2"	2"	1/2"	1/2
SH-2	TILE SHOWER, ADA	SHOWER VALVE, SHOWER TRIM, SPRAY HEAD, 36"SLIDE BAR, DIVERTER VALVE, 2"DIAMETER ROD, AMERICAN STANDARD 1662.213 OR EQUAL. SHOWERHEAD, MOEN 3838 OR EQUAL.	PROVIDE KOHLER K-7213-CP DRAIN. REFER TO ARCH SERIES FOR MOUNTING HEIGHTS. PROVIDE BLOCKING FOR SUPPORT & INSTALL PER MANUFACTURER RECOMMENDATIONS.	2"	2"	2"	1/2"	1/2'
BT-1	TUB & SHOWER (STANDARD): P.E.S., 60"×30"×15", KOHLER 61041120-0 STERLING ALL PRO SERIES 6104 OR EQUAL.	BATH/SHOWER VALVE, POLISHED CHROME, MOEN T62132NH VALVE 62370. DIVERTER TUB SPOUT, CHROME PLATED DELTA RP7533 OR EQUAL. CHROME PLATED SHOWERHEAD, MOEN 3838 OR EQUAL.	PROVIDE KOHLER K-7213-CP DRAIN. REFER TO ARCH SERIES FOR MOUNTING HEIGHTS. PROVIDE BLOCKING FOR SUPPORT & INSTALL PER MANUFACTURER RECOMMENDATIONS.	2"	2"	2"	1/2"	1/2
S-1	LAUNDRY SINK (TYPE 304, 14 GA), STAINLESS STEEL, WALL MOUNTED SINK, ELKAY ESSB2520C.	ROUGH CHROME FINISH, ELKAY LK907BR03L2H.	CAST-IRON P-TRAP, ELKAY 173. STOPS AND SUPPLIES, BRASSCRAFT OR EQUAL. SEE ARCH SERIES FOR MOUNTING HEIGHTS.	3"	3"	2"	3/4"	3/4
HS-1	HAND SINK, WALL HUNG, TYPE 304 STAINLESS STEEL, ADVANCE TABCO 7-PS-45 OR EQUAL.	PROVIDE FAUCET FROM SINK MANUFACTURER.	1-1/4" GRID WITH TAILPIECE, ZURN Z8743-PC. P-TRAP TO BE 1-1/2" BRASS (17 GA. MIN), ZURN ZR361-RB. PROVIDE SUPPLIES AND STOPS, ZURN Z8800 SERIES. INSTALL CONCEALED FLOOR MOUNTED ARM CARRIER. PROVIDE "LAV-GUARD" INSLUATION BY TRUBRO ON ALL EXPOSED TRIM.		1-1/2"	1-1/2"	1/2"	1/2
MB-1	MOP BASIN, GRAY PRECAST TERRAZZO, 12"DEEP, 24"X24", STERN WILLIAMS COMPANY SBC-1700.	SERVICE SINK FAUCET, CHROME PLATED, STERN WILLIAMS T-10-VB.	PROVIDE 3"CAST BRASS CHROME-PLATED STRAINER, STAINLESS STEEL CAP, HOSE AND WALL HOOK, SPLASH CATCHER PANELS, AND MOP HANGER BRACKET. PROVIDE 3" P-TRAP.	3"	3"	2"	3/4"	3/4
I M-1	REFRIGERATOR ICE MAKER BOX CONNECTION. GUY GRAY BIM876.		CHROME PLATED WALL ELBOW, DELTA 50560.				1/2"	
WM-1	WASHING MACHINE CONNECTION BOX, GUY-GRAY B200-TS.		3/4" HOSE THREADED WATER CONNECTIONS AND 2" WASTE CONNECTION, WITH 2 WATTS 80 VACUUM BREAKERS WITH CHROME FINISH AND 2" P-TRAP.	2"	2"	1-1/2"	1/2"	1/2
DF-1	DUAL HEIGHT ELECTRIC WATER COOLER, ADA COMPLIANT, WALL HUNG WITH 8.0 GPH CAPACITY OF 50°F DRINKING WATER AT 80°F INLET AND 90°AMBIENT TEMPERATURE, ELKAY EZSTL8WSLK OR EQUAL. SEE ARCH SERIES FOR MOUNTING HEIGHTS.		PUSH BARS AND PUSHBAR ATTACHMENT HARDWARE TO BE METAL. FOUNTAIN AND CABINETS TO BE SATIN STAINLESS STEEL. P-TRAP TO BE 1-1/2" BRASS (17 GA. MIN), ZURN ZR365-PC. PROVIDE SUPPLIES AND STOPS. INSTALL CONCEALED FLOOR MOUNTED ARM CARRIER.		1-1/2"	1-1/2"	1/2"	1/2
NFHB-1	WALL HYDRANT (NON-FREEZE), KEY OPERATED WITH CHROME PLATED FACE, INTEGRAL VACUUM BREAKER, WATTS HY-420.		3/4" HOSE CONNECTION, ALL BRONZE HEAD, SEAT CASTING AND INTERNAL WORKING PARTS, GALVANIZED WALL CASING AND HYDRANT KEY.				3⁄4 "	
EW-1	FLOOR MOUNTED PEDESTAL EMERGENCY EYEWASH STATION EQUAL TO GUARDIAN G1825 WITH STAINLESS STEEL BOWL AND SPRAY HEADS WITH FLIP TOP COVERS. PROVIDE WITH G3600LF THERMOSTATIC MIXING VALVE AND HOLD OPEN VALVE ABOVE THE CEILING.		PROVIDE CHROME PLATED 1-1/2" P-TRAP (17 GA. MIN)				3/4"	3/4

1

LINE TYPE DESCRIPTION SANITARY WASTE (SW) GREASE WASTE (GW) GW GREASE WASTE (GW) SANITARY VENT (SV) COLD WATER (CW) COLD WATER (CW) DWG HOT WATER (HW) DWG RD ROOF DRAIN (RD) OVERFLOW DRAIN (CD) ELEV CD CONDENSATE DRAIN (CD) CD CONDENSATE DRAIN (CD) CD FF FINISHED FLOOR CHECK VALVE MG BALL VALVE CONDENSATE DRAIN (CD) FF FINISHED FLOOR CHECK VALVE FC FLOOR CLEANOUT MECH MECHANICAL MECH MECHANICAL VENT THRU ROOF (VTR) O STRUCT STRUCTURAL TYP TYP ICAL WOO WALL CLEANOUT WHA WATER HAMMER ARRESTER ROOM NUMBER	LEGEND	ABBR	EVIATIONS	SYMBOLS	
	LINE TYPE DESCRIPTION GW SANITARY WASTE (SW) GW GREASE WASTE (GW) SANITARY VENT (SV) COLD WATER (CW) HOT WATER (HW) RD ROOF DRAIN (RD) OD OVERFLOW DRAIN (OD)	ARCH CO CONC DN DWG ELEV ELEC FF FCO MECH REQD SECT STRUCT TYP WCO	ARCHITECTURAL CLEANOUT CONCRETE DOWN DRAWING ELEVATION ELECTRICAL FINISHED FLOOR FLOOR CLEANOUT MECHANICAL REQUIRED SECTION STRUCTURAL TYPICAL WALL CLEANOUT	PIPE TURNED UP SOLENOID VALVE CAP BALANCING VALVE BALL VALVE CHECK VALVE HOSE FAUCET VENT THRU ROOF (VTR) CONNECT TO EXIST. PIPING KEY NOTE NUMBER	

I LOWDING NOILS.

1. ONLY KNOWN SERVICES IN THE PROJECT AREA ARE SHOWN IN DRAWING SET. CONTRACTOR TO FIELD VERIFY EXACT CONDITIONS PRIOR TO BEGINNING WORK.

2. CONTRACTOR SHALL COORDINATE THE DISRUPTION OF ANY SERVICE WITH THE LOCAL OWNER'S REPRESENTATIVE A MINIMUM OF 72 HOURS PRIOR TO DISRUPTION.

3. CONTRACTOR SHALL COORDINATE EQUIPMENT CONNECTIONS WITH EQUIPMENT DRAWINGS AND SUPPLIER. CONTRACTOR SHALL INSTALL EQUIPMENT AND MAKE FINAL CONNECTIONS FURNISHING CUTOFF VALVES, P-TRAPS, PRESSURE REDUCING VALVES, AND PIPING AS REQUIRED.

4. CONTRACTOR SHALL FURNISH AND INSTALL SHOCK ABSORBERS ON PIPING SERVING FLUSH VALVE FIXTURES AND/OR QUICK CLOSING VALVES (SOLENOID OPERATED, ETC.) IN ACCORDANCE WITH "PLUMBING AND DRAINAGE INSTITUTE" (PDI-WH-201) GUIDELINES.

5. CONTRACTOR SHALL COORDINATE WITH ALL DISCIPLINES INVOLVED TO AVOID ANY PIPE ROUTING PROBLEMS. IN THE EVENT CONFLICTS ARE ENCOUNTERED WHICH CANNOT BE RESOLVED BY THE TRADES INVOLVED, THE ARCHITECT SHALL BE CONSULTED AND HIS DECISION SHALL GOVERN.

6. ALL VENTS SHALL BE A MINIMUM OF 15'-0" AWAY FROM ALL FRESH AIR INTAKES FOR AIR HANDLING UNITS.

7. WHERE ROOF PENETRATIONS OF VENTS AND WASTE STACKS LESS THAN THREE INCHES (3") ARE PROHIBITED BY CODE. PROVIDE INCREASERS IN PIPE BELOW ROOF SLAB.

8. FURNISH AND INSTALL DEEP SEAL P-TRAPS ON FLOOR DRAINS NOT FED BY AN AUTOMATIC TRAP PRIMER SYSTEM, WHERE REQUIRED BY CODE.

9. ALL FIXTURES, EQUIPMENT AND PIPING SHOWN ON THESE DRAWINGS SHALL BE INSTALLED IN ACCORDANCE WITH ALL APPLICABLE FEDERAL, STATE AND LOCAL CODE REQUIREMENTS.

10. PENETRATIONS THROUGH NEW WALLS AND FLOORS SHALL BE SLEEVED AND/OR PATCHED AS DIRECTED BY THE SPECIFICATIONS. SEE ARCHITECTURAL DRAWINGS FOR FINAL FINISHES.

11. ALL NEW PIPE PENETRATIONS OF FIRE RATED WALLS, AS SHOWN BY THE LIFE SAFETY PLANS, SHALL HAVE A UL LISTED F RATING EQUAL TO THE WALL FIRE RATING.

12. ALL WORK SHOWN IS PART OF BASE BID EXCEPT WHERE OTHERWISE DESIGNATED.

13. SEISMICALLY BRACE ALL PIPE AS REQUIRED BY LOCAL CODE REQUIREMENTS.

14. PIPING SHALL NOT BE INSTALLED OVER ELECTRICAL EQUIPMENT.

15. CAULK AROUND ALL PLUMBING FIXTURES. CAULK COLOR SHALL MATCH PLUMBING FIXTURE COLOR.

16. EXACT LOCATIONS OF MECHANICAL EQUIPMENT SHALL BE VERIFIED WITH THE MECHANICAL CONTRACTOR. ALL REQUIRED CONDENSATE PIPING SHALL BE COORDINATED WITH THIS EQUIPMENT.

17. SANITARY SEWER PIPING SHALL BE SLOPED AS FOLLOWS: 4" SANITARY WASTE PIPING AND LARGER SHALL BE ROUTED AT 1/8" PER FOOT MINIMUM. 3" SANITARY WASTE PIPING AND SMALLER SHALL BE ROUTED AT 1/4" PER FOOT MINIMUM.

18. CONTRACTOR TO PROVIDE PROPERLY SIZED ISOLATION VALVES AT ALL DOMESTIC WATER BRANCH PIPING AND ALL DOMESTIC WATER PIPING SERVING INDIVIDUAL FIXTURES OR RESTROOMS. VALVES TO BE INSTALLED IN AN ACCESSIBLE LOCATION ABOVE TILE CEILING.

19. CONTRACTOR TO PROPERLY BALANCE DOMESTIC HOT WATER AND HOT WATER RETURN SYSTEMS. CONTRACTOR TO PROVIDE BALANCING VALVES ON HOT WATER RETURN PIPING AS NECESSARY.

20. WALL CLEANOUTS INSTALLED IN LARGE BACK TO BACK RESTROOMS IN THE BUILDING SHALL BE INSTALLED WITH ACCESS FROM THE BOYS' RESTROOM SIDE.

21. CONTRACTOR SHALL ESTABLISH A SEQUENCE OF INSTALLATION WITH OTHER TRADES WORKING ON THE PROJECT. CONTRACTOR SHALL THOROUGHLY COORDINATE ALL SYSTEMS WITH OTHER TRADES.

22. CATHODIC PROTECTION, IF REQUIRED, IS THE CONTRACTOR'S RESPONSIBILITY. CONTRACTOR SHALL PROTECT ALL UNDERGROUND METALLIC PIPING FROM CORROSION. REFER TO SOILS REPORT. UNDERGROUND PIPING MAY ALSO BE PROTECTED WITH POLYETHYLENE ENCASEMENT CONFORMING TO ANSI/AWWA REQUIREMENTS. ALL PIPING SHALL BE WRAPPED COMPLETELY WITH ENCASEMENT TO A POINT AT LEAST 12 A.F.G OR FIN. FLOOR. ENCASEMENT SHALL BE FREE OF TEARS WITH ALL JOINTS COMPLETELY SEALED. NO PORTION OF THE PIPE SHALL BE LEFT EXPOSED TO CORROSIVE SOIL.

23. NO PLASTIC PIPING SHALL BE ROUTED IN A RETURN AIR PLENUM.



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ISSUES & REVISIONS
NO. DATE DESCRIPTION 1 01/19/2016 FOR CONSTRUCTION 2 03/11/2016 REVISION # 2
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PROJECT NAME:
PROJECT NUMBER:
DRAWING NAME:
LEGEND, NOTES, & SCHEDULE - PLUMBING
DRAWN BY: MDP CHECKED BY: MDP
date: 01-19-16 scale: AS NOTED
DRAWING NUMBER
P001

DRAIN & CLEANOUT SCHEDULE

2

TAG DESCRIPTION FLOOR DRAIN: (STANDARD) FD-1 SET TOP OF DRAIN 1/2" BELOW FINISHED FLOOR ELEVATION. FD-2 FLOOR DRAIN (MECHANICAL):

1

HD-1	HUB DRAIN (STANDARD): CAST-IRON HUB DRAIN. PROVIDE TRAP UNLESS OTHERWISE NOTED. SET TOP OF DRAIN
TD-1	TRENCH DRAIN (ADA, KITCHEN): MODULAR SECTION, TYPE 304 STAINLESS STEEL, 6"WIDE FACE, PRE-SLOPED CHANNEL STYLE AND TYPE TO BE COORDINATED WITH ARCHITECT FOR FINAL SELECTION, EQUAL INSTALL PER MANUFACTURER RECOMMENDATIONS.
FS-1	FLOOR SINK: (HALF GRATE) 12"×12"×10" DEEP CAST IRON FLOOR SINK WITH ANCHOR FLANGE, WITH SEEPAGE HOL STRAINER, ACID RESISTANT PORCELAIN INTERIOR WITH ACID RESISTANT HALF GRATE SET TOP OF DRAIN FLUSH WITH FINISHED FLOOR.
FS-2	FLOOR SINK: (OPEN GRATE) 12"×12"×10" DEEP CAST IRON FLOOR SINK WITH ANCHOR FLANGE, WITH SEEPAGE HOL STRAINER, ACID RESISTANT PORCELAIN INTERIOR LESS GRATE EQUAL TO ZURN 1902 FLUSH WITH FINISHED FLOOR.
WCO	WALL ACCESS COVER: ROUND STAINLESS STEEL ACCESS COVER WITH 1/4-20 X 3-1/2" CENTER SCREW TO BE CLEANOUT PLUG WITH A 1/4"-20 TAPPED HOLE EQUAL TO WADE W-8480R8.
FC0	FLOOR CLEANOUT: CAST IRON CLEANOUT W/ THREADED, ADJUSTABLE HOUSING, FLANGED FERRULE W/ TAPI SECURED NICKEL BRONZE SCORIATED TOP. EQUAL TO WADE W-6000-TY.

GRADE CLEANOUT: GCO CAST IRON CLEANOUT W/ THREADED, ADJUSTABLE HOUSING, FLANGED FERRULE W/ TAPERED BRASS PLUG, ROUND SECURED NICKEL BRONZE VENEER TRACTOR TYPE COVER WITH SECURITY CREWS. EQUAL TO WADE W-6004Z-179-TY.

2

NOTES: 1. TAP AND TEST "T" SHALL NOT BE USED FOR WALL CLEAN-OUTS.

Δ

1

DOMESTIC WATER BOOSTER PUMP SCHEDULE

4

QUANTITY	LOCATION	SERVICE	MANUFACTURER	MODEL	GPM EACH PUMP	EST. HEAD FT.	RPM EACH PUMP	HORSEPOWER EACH PUMP	ELECTRICAL CHARACTERISTICS	TYPE
1	MECH ROOM	DOMESTIC	ARMSTRONG	6901	60	60	3600	5		CONSTANT SPEED - DUPLEX PUMPS NO-FLOW SHUT DOWN

1. PROVIDE DUPLEX ARRANGEMENT AS A PRE PIPED PRE WIRED PACKAGED SYSTEM. FURNISH WITH CONTROL PANEL INCLUDING GAUGES FOR INCOMING AND DISCHARGE PRESSURE,

2. STARTERS WITH DISCONNECT SWITCH, AND OVERLOAD & HAND OFF AUTOMATIC SWITCH. PROVIDE PRESSURE CONTROL WITH SUCTION CUT-OUT & TIME CLOCK ALTERNATOR.

3. PACKAGE SHALL INCLUDE 106 GALLON 125# ASME BLADDER TANK MOUNTED ON SAME BASE AS PUMPS AND CONTROLLER. 4. PROVIDE ISOLATION VALVES AND CHECK VALVES ON THE INLET AND DISCHARGE SIDE OF EACH PUMP. SYSTEM SHALL BE CAPABLE OF PRODUCING A PSI PRESSURE BOOST AT 202 GPM.

5. PROVIDE VIBRATION ISOLATION DAMPERS.

1

			WATER HE	ATER	SCHE	DULE	. – N	ATU	RAL	GAS	5			
MARK	QTY.	MANUFACTURER	MODEL NO.	LOCATION	SYSTEM	FUEL	BTUH	E.W.T.	L.W.T.	RECOVERY (GPH)	STORAGE (GALLONS)	FUEL CONN.	FLUE DIA.	REMARKS
WH-1	1	A.O. SMITH	BTH-199	SEE DWG	DOM. H.W.	NAT. GAS	199,000	40° F	140° F	230	100	3/4"	3"	
WH-2	1	A.O. SMITH	BTH-199	SEE DWG	DOM. H.W.	NAT. GAS	199,000	40° F	140° F	230	100	3⁄4"	3"	
WH-2	1	A.O. SMITH	BTH-199	SEE DWG	DOM. H.W.	NAT. GAS	199,000	40° F	140° F	230	100	3∕4"	3"	
WH-2	1	A.O. SMITH	BTH-199	SEE DWG	DOM. H.W.	NAT. GAS	199,000	40° F	140° F	230	100	3∕4"	3"	

					EST.
LOCATION	SERVICE	MANUFACTURER	MODEL	GPM	HEAD
MECH. ROOM	DOM. HWR	GRUNDFOS	UP15-18SU	10	35'

4

MARK	QTY.	SYSTEM	MANUFACTURER	MODEL	SIZE	GPM	PRESSURE DROP	REMARKS
BFP-1	1	DOM. WATER	WATTS	909 OSY	3"	100	12 PSI	
1 INCLUDE WATTS 919AGF AIR GAP.								

CAST IRON FLOOR DRAIN WITH FLANGE, INTEGRAL CLAMPING COLLAR, SEEPAGE OPENINGS, ADJUSTABLE 5" SQUARE NICKEL BRONZE STRAINER WITH VANDAL PROOF SCREW AND 1/2" PLUGGED PRIMER TAP, WADE W-1104G-TY.

3

CAST IRON FLOOR DRAIN WITH FLANGE, INTEGRAL CLAMPING COLLAR, SEEPAGE OPENINGS, 1/2" PLUGGED PRIMER TAP AND SQUARE ADJUSTABLE HEAVY 8-INCH SQUARE NICKEL BRONZE TOP WITH LOOSE SET TRACTOR GRATE, WADE 1100-G. FURNISH AND INSTALL DEEP SEAL P-TRAP. SET TOP OF DRAIN TO 1/2" BELOW FINISHED FLOOR ELEVATION.

IN 1/2" AFF.

ELS, STAINLESS STEEL GRATE AL TO J.R. SMITH 9660 SERIES.

DLES CLAMP COLLAR, BOTTOM DOME E EQUAL TO ZURN 1902 SERIES.

DLES CLAMP COLLAR, BOTTOM DOME SERIES. SET TOP OF DRAIN

USED WITH COUNTERSINK

PERED BRASS PLUG, ROUND


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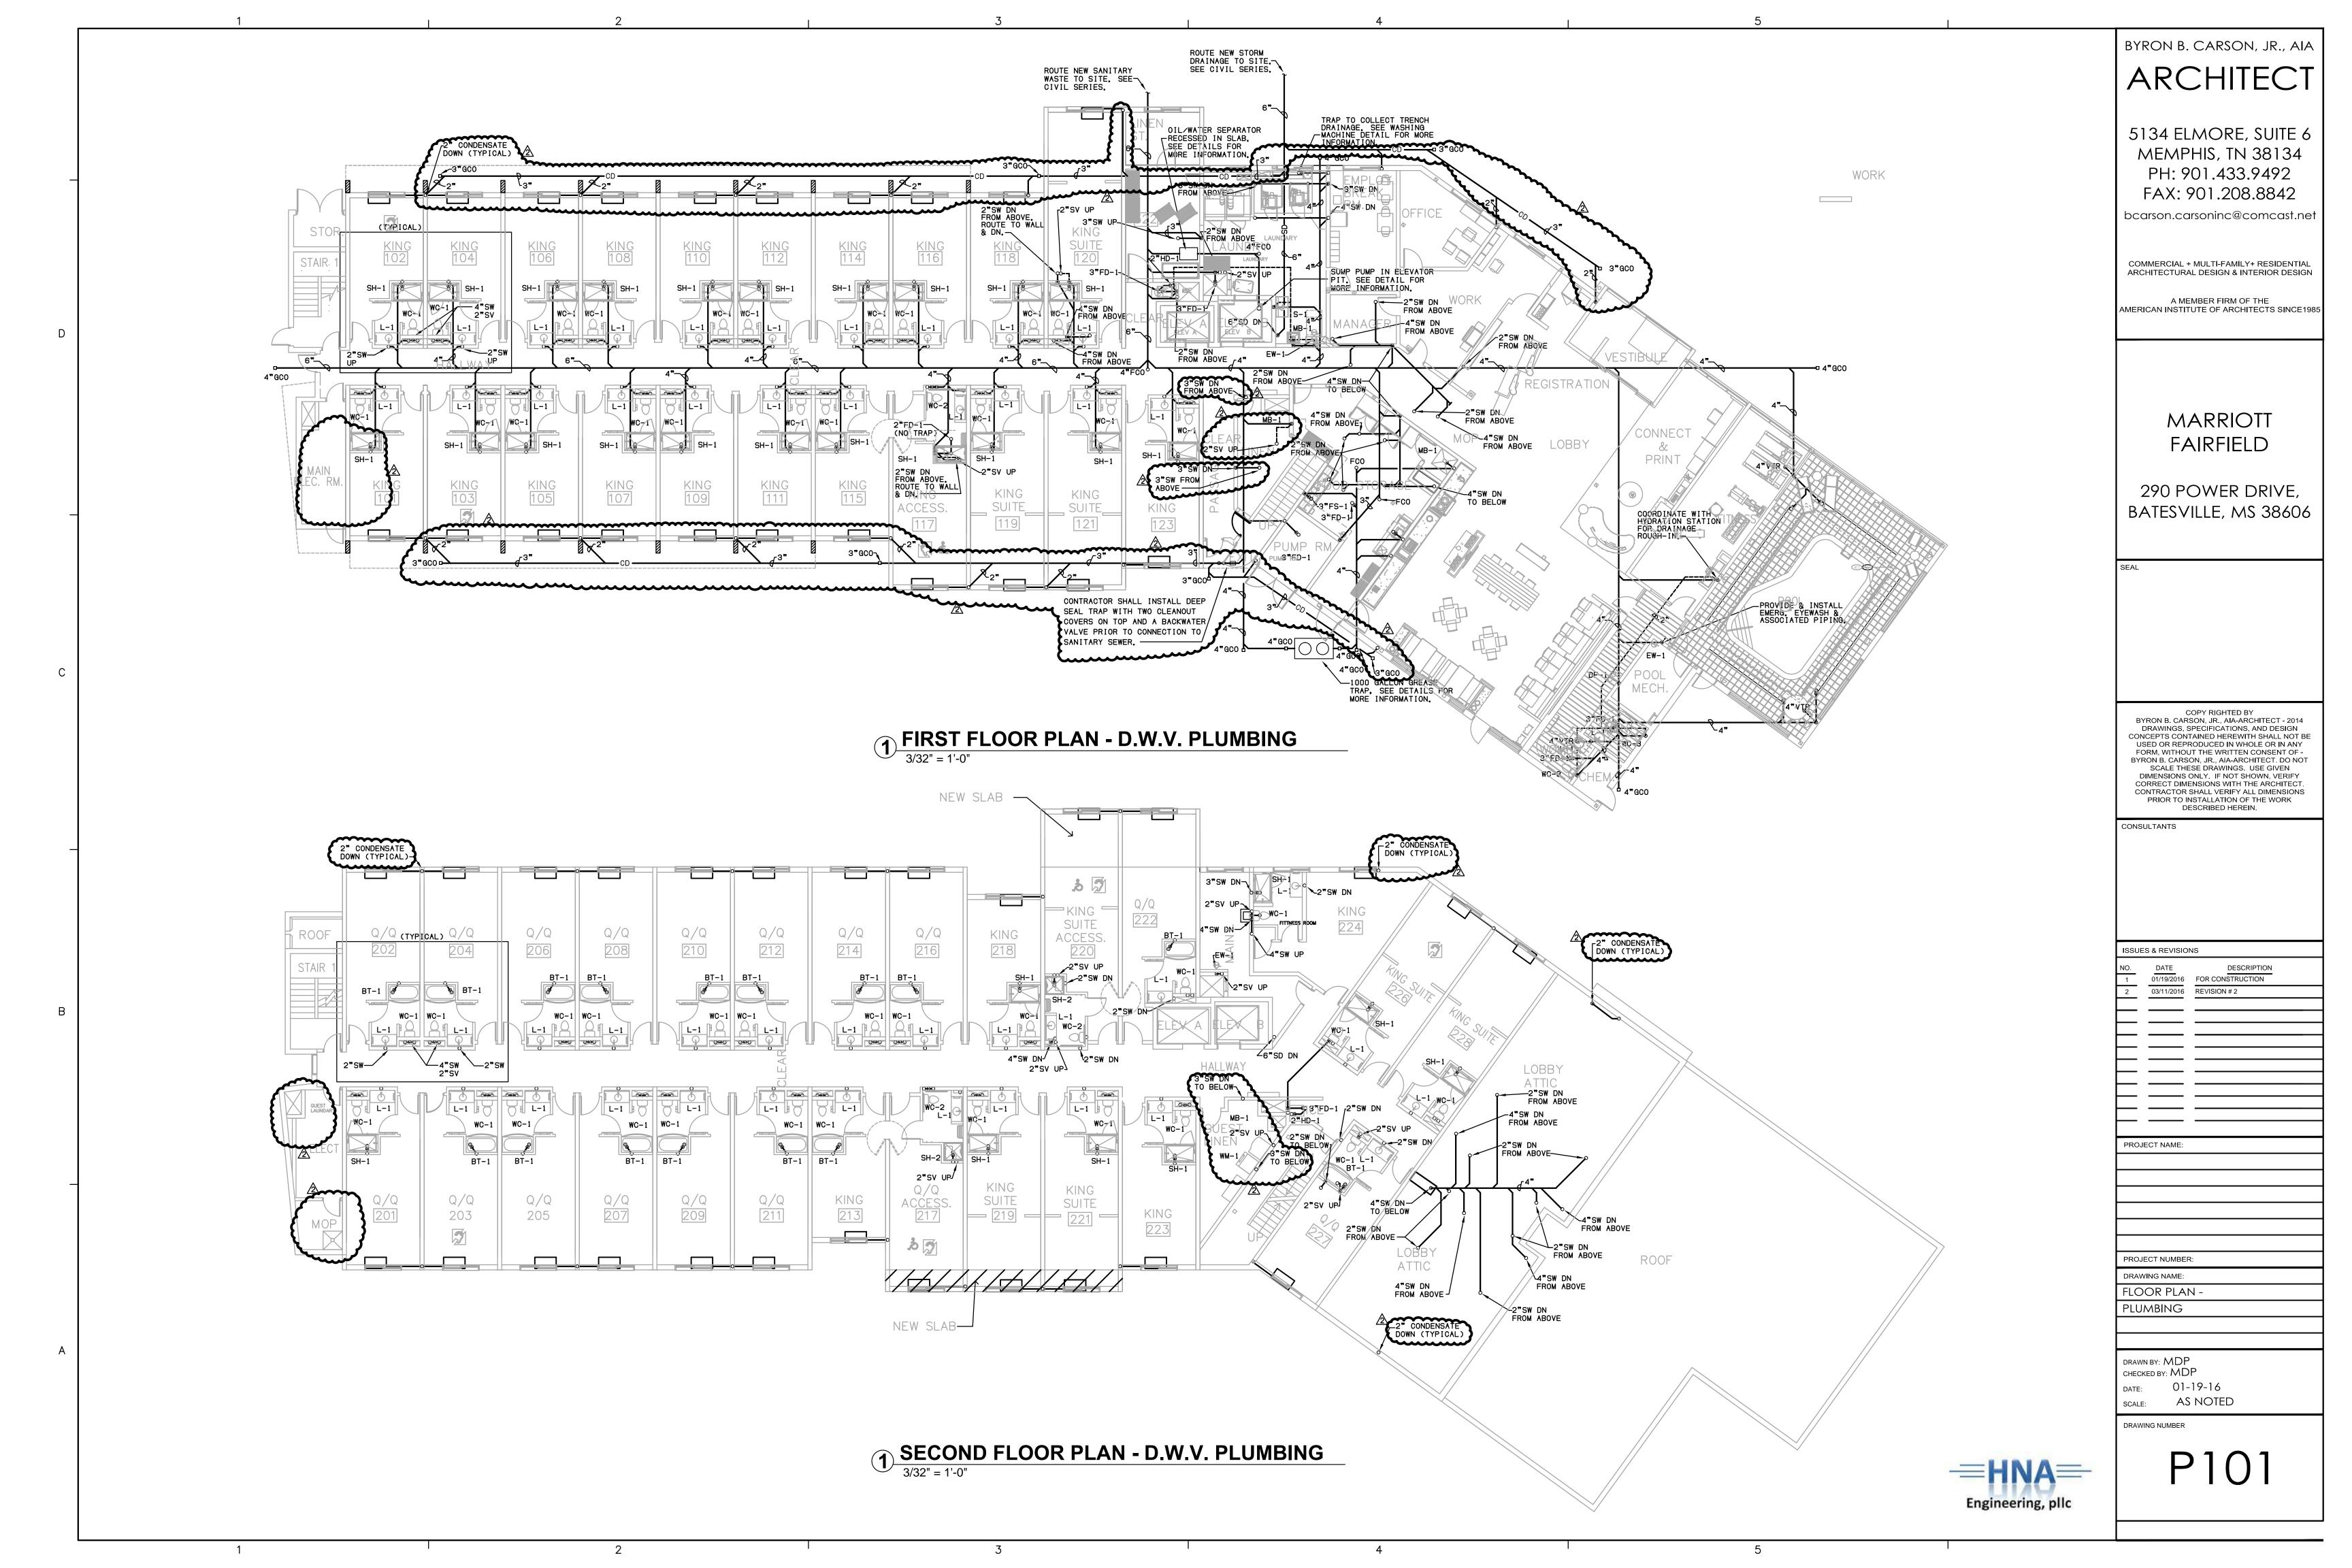
RPM HORSEPOWER 1/4 -


ELECTRICAL CHARACTERISTICS 120V/1¢/60 Hz.

TYPE IN-LINE


SCHEDULE



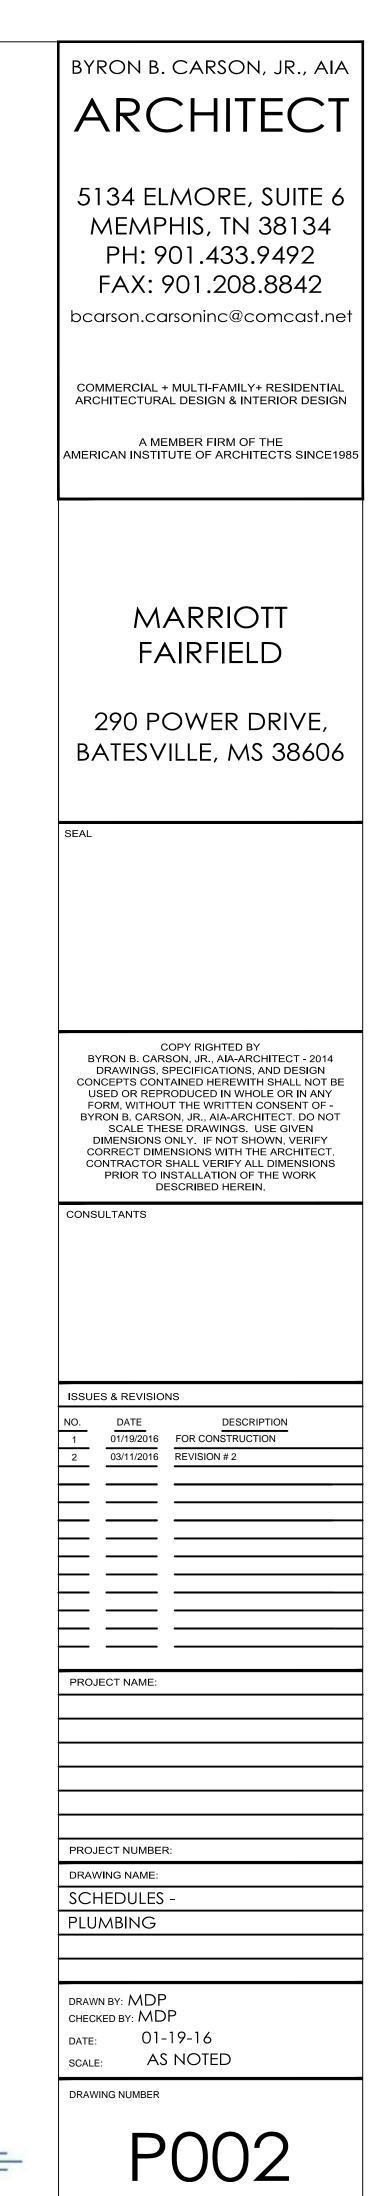


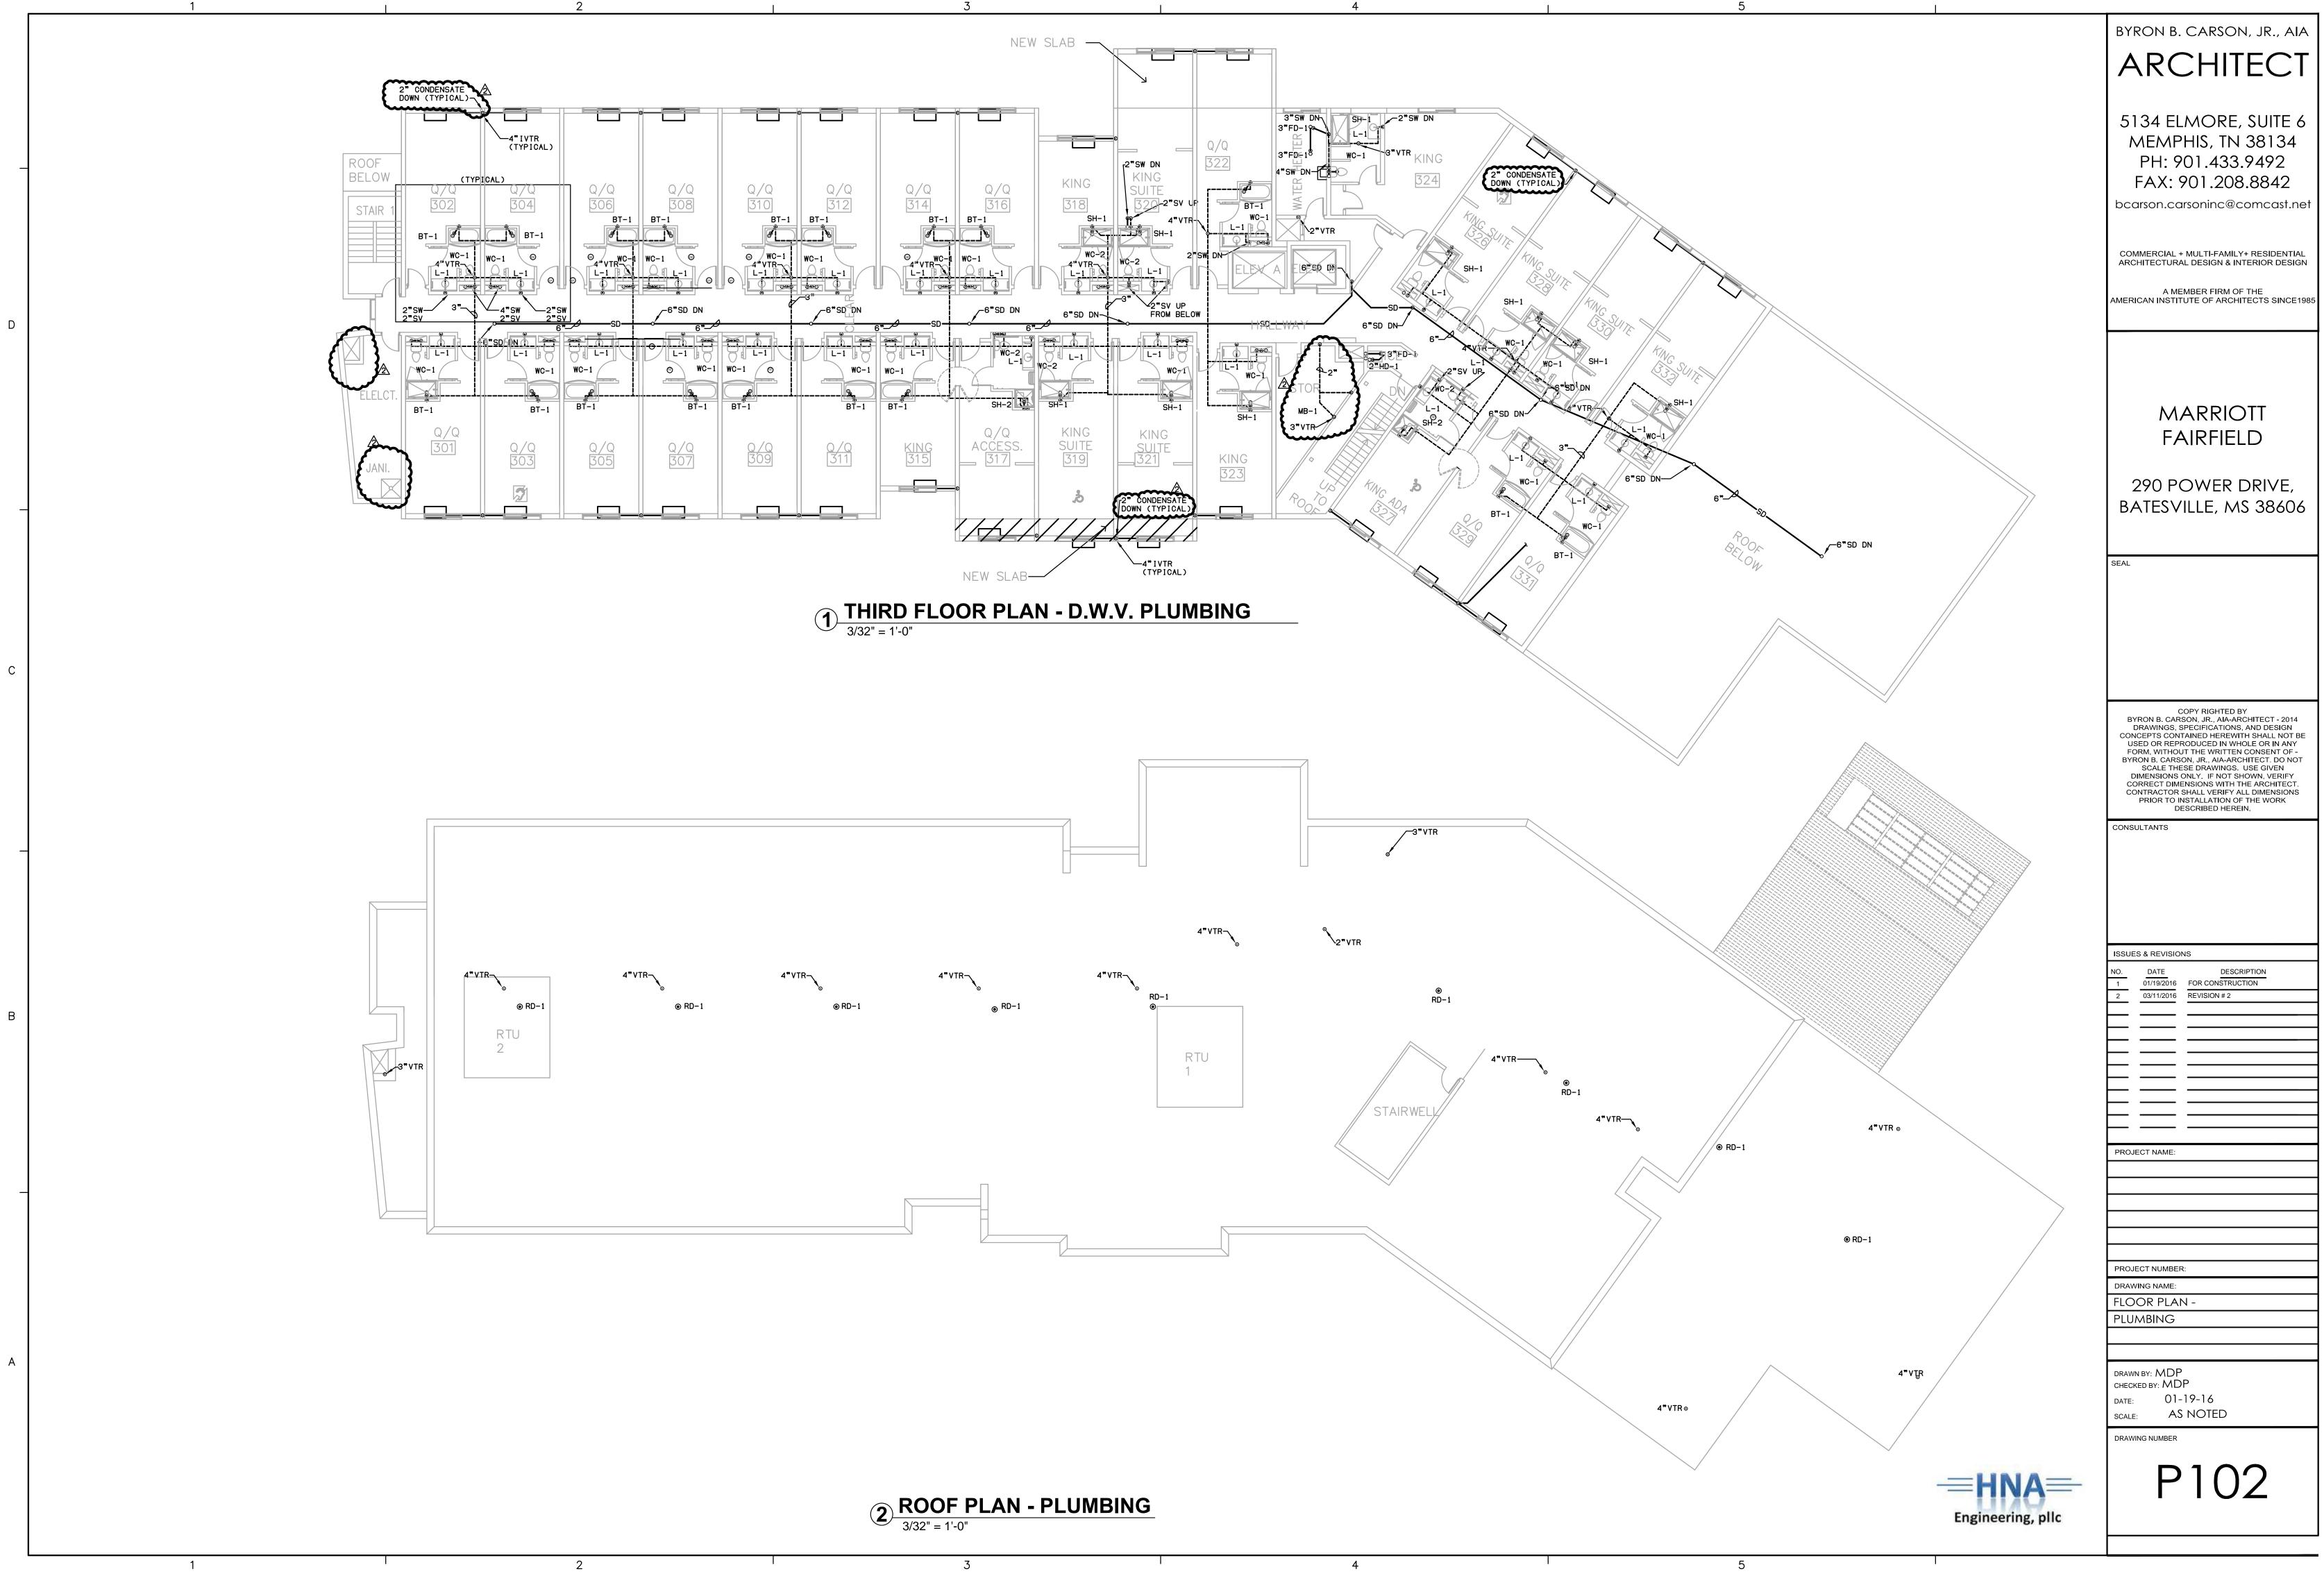



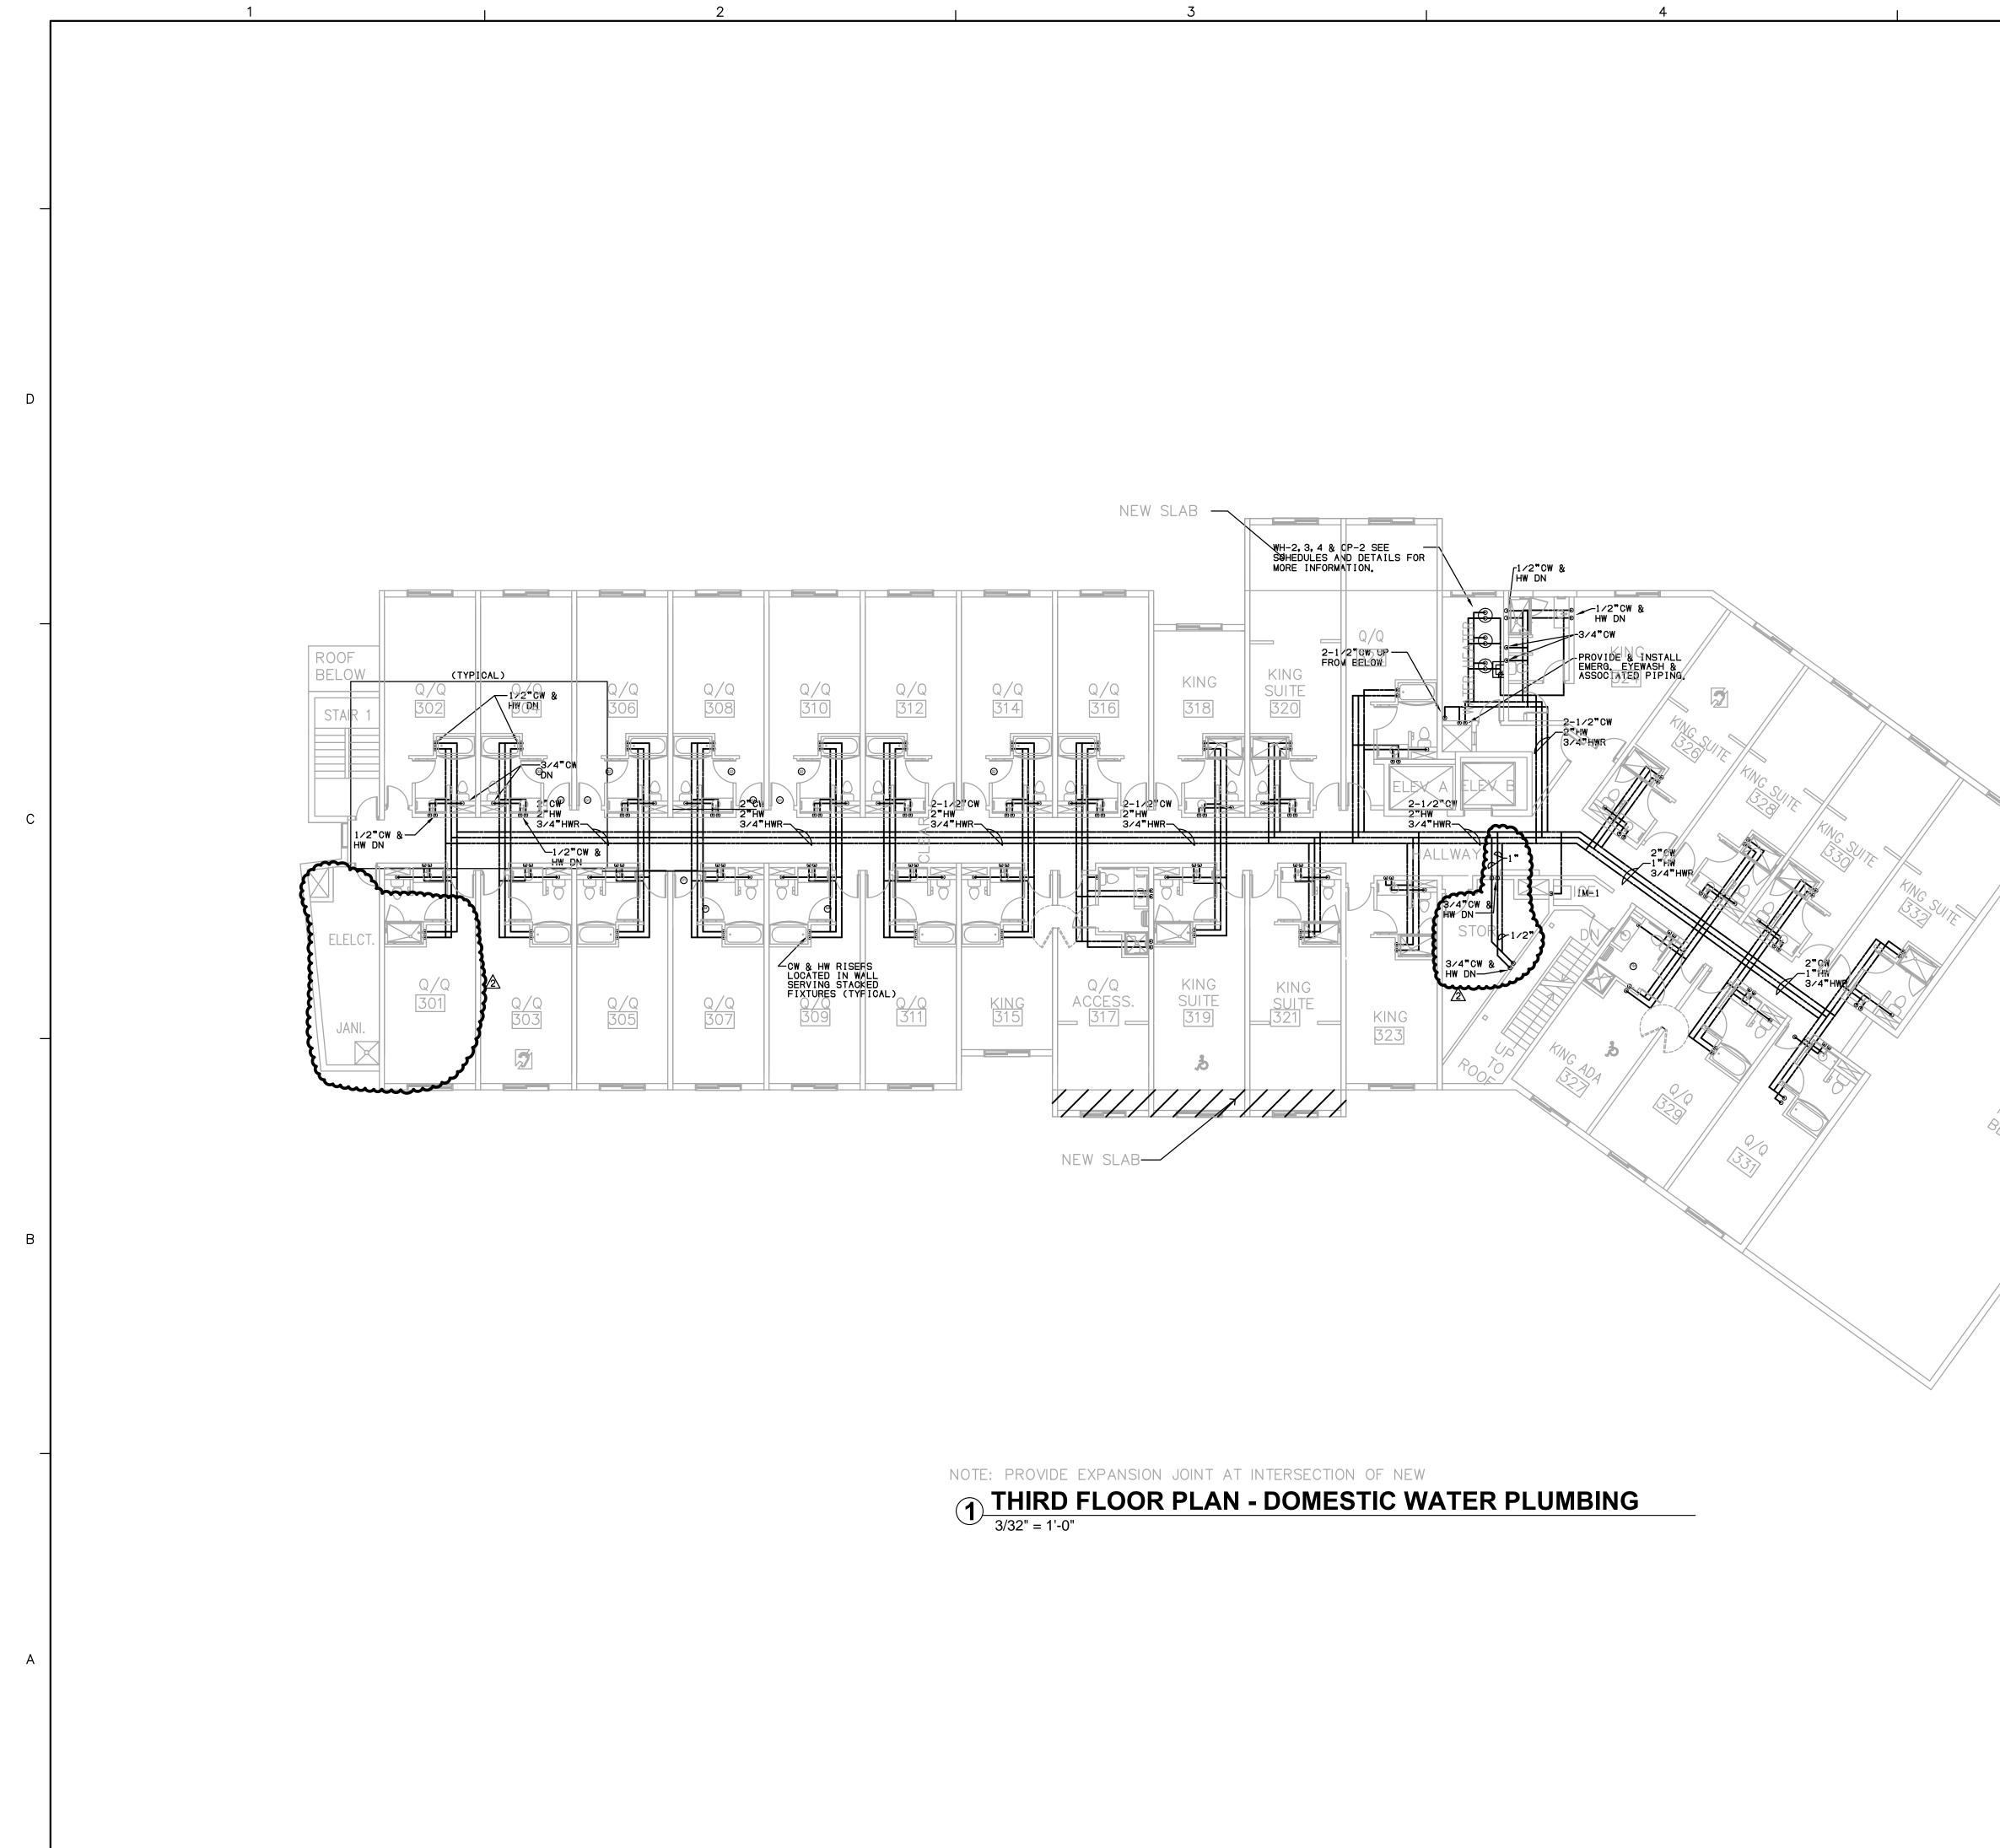

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	DRAWN BY: MDP CHECKED BY: MDP DATE: 01-19-16 SCALE: AS NOTED DRAWING NUMBER
Engineering, pllc	P104

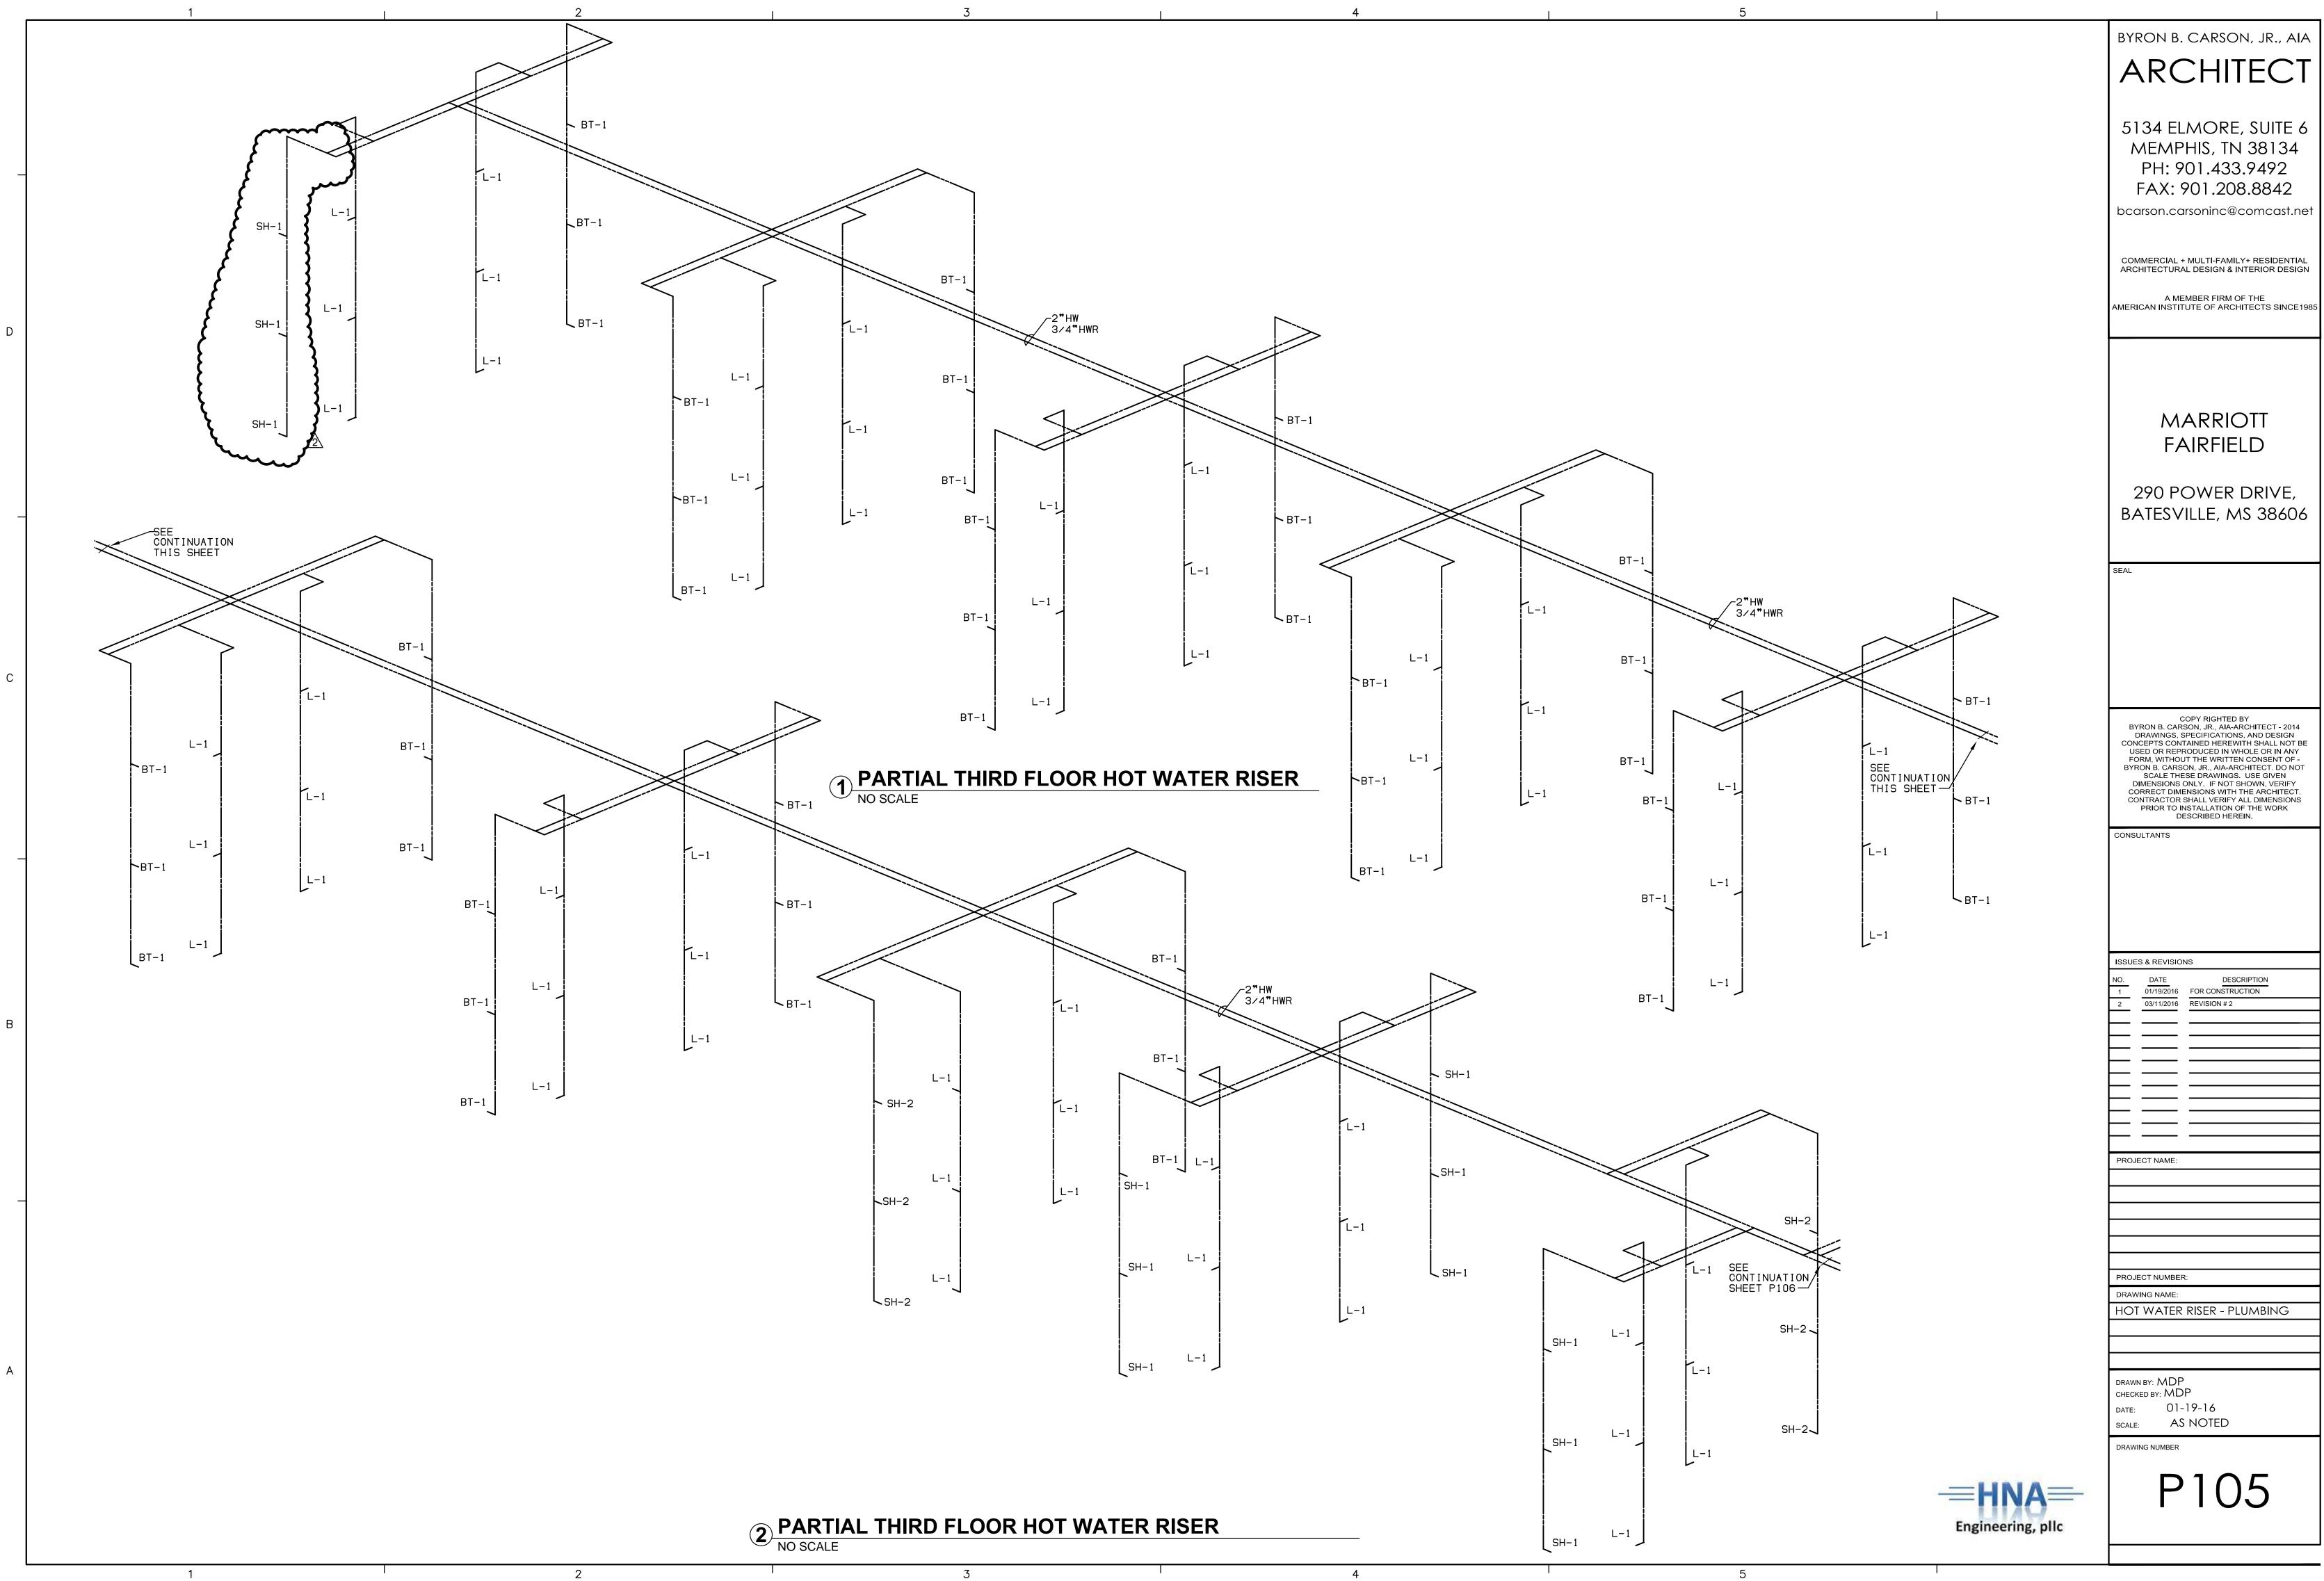

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